

#### MILWAUKIE PLANNING

6101 SE Johnson Creek Blvd Milwaukie OR 97206 503-786-7630 planning@milwaukieoregon.gov

## Application for Land Use Action

Primary File #: DEV-2023-003

		Review type*: $\square$ I $\square$ II $\square$ III $\square$ IV $\square$ V				
CHECK ALL APPLICATION TYPES THAT APPLY:  Amendment to Maps and/or  Comprehensive Plan Map Amendment  Zoning Text Amendment  Zoning Map Amendment  Code Interpretation  Community Service Use  Conditional Use  Development Review  Director Determination  Downtown Design Review  Extension to Expiring Approval  Historic Resource:  Alteration  Demolition  Status Designation  Status Deletion	□ Land Division: □ Final Plat □ Lot Consolidation □ Partition □ Property Line Adjustment □ Replat □ Subdivision □ Mixed Use Overlay Review □ Modification to Existing Approve ☑ Natural Resource Review** □ Nonconforming Use Alteration □ Parking: □ Quantity Determination □ Quantity Modification □ Shared Parking □ Structured Parking	☐ Planned Development ☐ Residential Dwelling ☐ Manufactured Dwelling Park ☐ Manufactured Dwelling ☐ Temporary Dwelling Unit ☐ Transportation Facilities Review** ☐ Variance: ☐ Use Exception ☐ Variance ☐ Willamette Greenway Review ☐ Other: ☐ Use separate application forms for: Annexation and/or Boundary Change ● Compensation for Reduction in Property ● Value (Measure 37) ☐ Daily Display Sign ● Appeal				
RESPONSIBLE PARTIES:						
APPLICANT (owner or other eligible	applicant—see reverse): Pete	er Passarelli				
Mailing address: 10722 SE Main S	Street, Milwaukie, OR	State/Zip: 97222				
Phone(s): 503.786.7614	Email: Pa	assarelliP@milwaukieoregon.gov				
Please note: The information submitted in this application may be subject to public records law.						
APPLICANT'S REPRESENTATIVE (if diff	erent than above):Matt Hasti	e, AICP				
Mailing address:506 SW 6th Ave, S	State/Zip:97204					
Phone(s): 503-539-7680 Email: mhastie@migcom.com						
SITE INFORMATION:						
Address: 10660 SE 21st Ave. Map & Tax Lot(s): 11E36BB01900						
Comprehensive Plan Designation: Public use Zoning: Open Space (OS) Size of property: 20,400 sf						
PROPOSAL (describe briefly):						
This project will remodel and update Scott Park. The existing path and part of the lawn will be removed to						
accomodate a new play area, walki	ing trails, and other features.	Γhe amphiteater will be updated as well.				
<b>SIGNATURE:</b> I attest that I am the property owner or I am eligible to initiate this application per Milwaukie Municipal Code Subsection 19.1001.6.A. If required, I have attached written authorization to submit this application. To the best of my knowledge, the information provided within this application package is						

### IMPORTANT INFORMATION ON REVERSE SIDE

Date: 06/23/2023

complete and accurate

Submitted by:

<sup>\*</sup>For multiple applications, this is based on the highest required review type. See MMC Subsection 19.1001.6.B.1.
\*\* Natural Resource and Transportation Review applications may require a refundable deposit.

#### WHO IS ELIGIBLE TO SUBMIT A LAND USE APPLICATION (excerpted from MMC Subsection 19.1001.6.A):

**Type I, II, III, and IV** applications may be initiated by the property owner or contract purchaser of the subject property, any person authorized in writing to represent the property owner or contract purchaser, and any agency that has statutory rights of eminent domain for projects they have the authority to construct.

Type V applications may be initiated by any individual.

#### PREAPPLICATION CONFERENCE:

A preapplication conference may be required or desirable prior to submitting this application. Please discuss with Planning staff.

#### **DEPOSITS:**

Deposits require completion of a Deposit Authorization Form, found at www.milwaukieoregon.gov/building/deposit-authorization-form

#### **REVIEW TYPES:**

This application will be processed per the assigned review type, as described in the following sections of the Milwaukie Municipal Code:

• Type I: Section 19.1004

• Type II: Section 19.1005

• Type III: Section 19.1006

• Type IV: Section 19.1007

• Type V: Section 19.1008

#### THIS SECTION FOR OFFICE USE ONLY:

FILE TYPE	FILE NUMBER	<b>AMOUNT</b> (after discount, if any)	PERCENT DISCOUNT	DISCOUNT TYPE	DATE STAMP	
Primary file	DEV-2023-001	\$ 200	100%	City-sponsored application	Materials submitted	
Concurrent application files	NR-2023-001	\$ 1,000	100%	City-sponsored application	6/23/2023	
application lies		\$			(no payment required)	
		\$				
		\$				
Deposit (NR/TFR only)				☐ Deposit Autho	orization Form received	
TOTAL AMOUNT RECEIVED: \$ RECEIPT #: RCD BY:						
Associated application file #s (appeals, modifications, previous approvals, etc.):						
Associated appli	culion life #3 (up	Neighborhood District Association(s): Historic Milwaukie				
	•	n(s): Historic Mi	lwaukie		_	

# Milwaukie Parks Land Use Planning and Permitting **Scott Park**

Site Development Review Natural Resource Review APPLICATION

Submitted to:

## City of Milwaukie

Submitted by:
Matt Hastie, AICP, MIG | APG

July 2023

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#### List of Attachments:

- A. 30% Design Concept Drawings
- B. Scott Park Materials Plan
- C. Erosion Control and Construction Access Plan
- D. Stormwater Drainage Report
- E. Property Deed
- J. Park Amenity Images
- M. Arborist Report

#### 1. Introduction

#### **Project Team**

#### Owner

City of Milwaukie Adam Moore 10722 SE Main Street Milwaukie, OR 97222 503-786-7624 moorea@milwaukieoregon.gov

#### Landscape Architect

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#### Civil

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#### **Land Use Planners**

MIG
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#### **Consulting Arborist**

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#### **Project Summary**

#### Site Description:

The site is located at 10660 SE 21st Ave. (tax lot 1900 and part of tax lot 1800) and defined by Ledding Library to the south, a pond to the east, and adjacent developments and parking areas to the north and west. The total site area is 20,400 square feet (sf). The site currently is designated as a natural resource area due to the valuable habitat it provides for domestic and migratory waterfowl. The park is a key pedestrian destination and serves as an important site for residential, commercial and civic functions.

The site is zoned primarily Open Space (OS), though the portion of the site on tax lot 1800 is zoned Dountown Mixed Use (DMU). The City's zoning ordinance states that "The Open Space Zone provides a specific zone to accommodate open space, park, and riverfront uses. The Open Space Zone is generally applied to lands that are in public ownership... The desired character for the Open Space Zone includes parkland, open space, and riverfront amenities." Per the Comprehensive Plan, the site is designated for Public use. The Public land use designation is intended for schools, parks, public open space, and other community uses. The park will be subject to the Natural Resource review and Site Development Review processes, standards, and approval criteria.

#### Proposed Improvements:

A variety of changes and improvements are proposed at the site, including the following as shown on the accompanying figure:

- The existing pathway and part of the lawn will be removed to accommodate new site features.
- A new play area will be constructed. The play area will be oriented towards younger children and will include new equipment such as small climbing structures and interactive musical features; the play area will have a rubberized surface to provide safety and a certain level of permeability and will be surrounded by a new retaining wall.
- A new drinking fountain, seating, bicycle parking, and interpretive signage also will be provided adjacent to the play area.
- Several new walking trails will be added. These trails will be made of pervious
  materials and meet the City's minimum width requirements (five feet) to minimize
  impacts while ensuring accessibility.
- New seating will be provided adjacent to one of the pathways to create a pond overlook area.
- One new tree and a large number of new shrubs (about 40) will be planted on the site. The majority of the new plants will be native species.

The existing amphitheater will remain, with no changes proposed. Similarly, no changes are proposed to the existing concrete wall and seating north of the amphitheater, the parking area and adjacent sidewalk, or the war memorial plaque, although the memorial plaque will be moved to a different spot, compared to its current location.

One tree that has been identified as diseased or dead and is proposed for removal as part of a separate process. More detailed information about the trees proposed for removal is found in the tree protection plan and arborist report associated with this application (Attachment A, Sheet L2.01 and Attachment M, Tree Inventory). The City will file a tree removal application permit at a later time, pursuant to MMC Section 16.32.026. d

The site includes a designated "Water Quality Resource Area" (WQRA) – pond and associated buffer area, as well as a "Habitat Conservation Area" (HCA), essentially a vegetated area associated with the pond. The only improvements proposed within the WQRA are replacement of existing pathways and placement of two wooden benches within the vegetated buffer area. The new pathways will be made of pervious materials and will replace existing non-pervious pathways. Several improvements are proposed within the boundaries of the HCA, including a portion of the new playground, associated retaining walls, pervious pathways, and seating. Impacts on these features generally qualify as exemptions or limited exemptions to standards applied in these areas and meet the requirements for a Type 1 review land use process. As a result, mitigation of impacts within the WQRA and HCA are not required by the development code. However, the City is planting a large number of new native plants which would meet mitigation requirements for a significant level of disturbance of the resource areas.

The proposed improvements to Scott Park build on incorporate the results of extensive concept planning and community engagement efforts conducted by the City and its planning team in 2022 and 2023. Throughout 2022, the city hosted three large public events, multiple online surveys and focus groups with Milwaukie's Black, Indigenous and People of Color (BIPOC) community members. After preparing and refining initial concepts, a revised draft Concept Plan for the park was approved by Milwaukie City Council on December 6, 2022. The proposed design and improvements build on and are generally consistent with those efforts. Scott Park also was the subject of a previous concept planning process undertaken by the North Clackamas Parks and Recreation District. However, that process was previously rescinded as part of the process of redeveloping the Ledding Library site.

#### 2. 19.304.4 Development Standards (OS Base Zone)

A. Lot Star	ndards	OS Zone
1. Minimu	m Lot Size	None
2. Minimu	m Street Frontage	None
B. Develop	oment Standards	
1. Floor ar	ea ratio	No min or max
2. Building	g Height	15 ft. max (see Subsection 19.304.5.B)
3. Flexible	ground-floor space	None
4. Set bac	ks/build to lines	0 ft minimum
5. Frontag	e occupancy requirements	None
6. Primary	entrances	No requirements
7. Off-Stre	eet parking required	Yes, where applicable (see Subsection 19.304.5.G and Chapter 19.600)
8. Open S	oace	Yes, where applicable (see Subsections 19.304.5.H and 19.508.4.G)
C. Other S	tandards	
1. Resider	tial density requirements	None
2. Signs		Yes (see Subsection 14.16.060)

#### 19.304.5.B Building Height

#### 2. Standards

There is no minimum building height per Table 19.304.4

The maximum building height for the site is 15 ft, per Table 19.304.4.

**Response:** The picnic shelter is proposed to be less than 15 feet tall, therefore the height standard is met.

#### 3. Height Bonuses

Response: This standard does not apply.

#### 4. Exemptions

The following are exempt from the minimum building height standards.

- a. Additions to existing buildings.
- b. Accessory structures.
- c. Buildings with less than 1,000 sq ft of floor area.

**Response:** These exemptions are not applicable to the project because there is no minimum building height in the OS base zone.

#### 19.304.5.D Setbacks and Build To Lines

2.(a) No minimum street setbacks are required.

**Response:** There are no applicable setback nor build-to line requirements for this zone. Therefore, this standard is not applicable.

#### 19.304.5.G Off-Street Parking

3. All nonresidential uses are exempt from the off-street parking requirements.

**Response:** This project is a nonresidential use and is therefore exempt from the off-street parking requirements.

#### 19.304.5.H Open Space

#### 2. Standards

a. When a building is set back from the sidewalk, at least 50% of the setback area shall provide usable open space, such as a public plaza or pedestrian amenities, that meets the standards of this subsection. Building setbacks cannot exceed the maximum setbacks established by Subsection 19.304.5.D and the frontage occupancy requirements of Subsection 19.304.5.E.

*Response:* There are no buildings proposed on this site, therefore this standard is not applicable.

b. Usable open space shall be abutted on at least two sides by retail shops, restaurants, offices, services, or residences with windows and entrances fronting on the space.

Response: Ledding Library is located south of the site and there is residential development to the east and west of the site. It is not clear if adjacent development has entrances fronting on the space, however the park is directly accessible from these developments. This space is intended for use by the neighborhood and broader Milwaukie community and is not associated with any specific downtown development. While this specific standard is not met, the development meets the intent of these open space standards "to provide amenities for downtown visitors and residents, promote livability, and help soften the effects of built and paved areas."

c. Usable open space must be accessible at grade adjacent to the sidewalk.

**Response:** As shown on Sheet L1.01, the site is currently accessible at grade via sidewalk from the parking area. Sheet L3.01 (demolition plan) shows that this sidewalk will remain in place, and Sheet L4.01 shows the planned paths through the park will intersect with the existing sidewalk. Therefore, this standard is met.

d. Open space may be hardscaped or landscaped, including plazas, courtyards, gardens, terraces, outdoor seating, and small parks.

**Response:** As shown on Sheet L4.01 a variety of materials, seating, and play equipment are planned for Scott Park, therefore this standard is met.

#### 3. 19.402 Natural Resources (NR)

#### 19.402.3 Applicability

A. The regulations in Section 19.402 apply to all properties that contain, or are within 100 ft of a WQR and/or HCA (including any locally significant Goal 5 wetlands or habitat areas identified by the City of Milwaukie) as shown on the Milwaukie Natural Resource Administrative Map (hereafter "NR Administrative Map").

- B. For properties that do not contain, but are within 100 ft of, a WQR and/or HCA, as shown on the NR Administrative Map, and where an activity not listed as exempt in Subsection 19.402.4.A will disturb more than 150 sq ft, a construction management plan is required in accordance with Subsection 19.402.9 (see also Table 19.402.3).
- C. The NR Administrative Map, which shows WQRs and HCAs, is adopted by reference. The NR Administrative Map shall be used to determine the applicability of Section 19.402 and shall be administered in accordance with Subsection 19.402.15.

Response: Per pre-application meetings with the City and subsection A, this project is subject to Natural Resource review procedure. Limited activities are proposed within the WQR, including replacement of existing trails with new trails constructed of pervious materials, placement of two benches, and minor grading/leveling work associated with the existing amphitheater stage. Some activities are proposed within the HCA as described in the following sections. The following evaluation is used to justify the review procedure for this application. As described in the following section, proposed activities within the HCA qualify as either Outright Exemptions or Limited Exemptions per Subsection 19.402.4.A or as Limited Exemptions per Subsection 19.402.4.B.

#### 19.402.4 Exempt Activities

#### 19.402.4.A. Outright Exemptions

The following activities in WQRs or HCAs are exempt from the provisions of Section 19.402:

4. The planting or propagation of plants categorized as native species on the Milwaukie Native Plant List.

**Response**: Per Sheet L8.00, plantings on the site include Cornus nuttallii, liriope muscari, and veronica americana listed on the Native Plant List. However, many other species are also included in the planting. This activity partially qualifies for an outright exemption. All trees proposed to be planted, Cornus nuttallii, are listed as natives and qualify for an exemption.

- 6. Removal of trees under any of the following circumstances:
  - d. Removal of the tree is in accordance with the requirements in Chapter 16.32 and an approved natural resource management plan per Subsection 19.402.10.

**Response:** One tree (see Sheet L2.01 of Attachment A) has been identified as dead and will be removed as part of a separate action and in accordance with Chapter 16.32. Therefore, this activity is exempt from Section 19.402. This will require a Type I Review (see next section.)

8. Additional disturbance for outdoor uses, such as gardens and play areas, where the new disturbance area does not exceed 150 sq ft; does not involve the removal of any trees of larger than 6-in diameter or otherwise regulated by Chapter 16.32; and is located at least 30 ft from the top of bank of a stream or drainage and at least 50 ft from the edge of a wetland.

**Response:** The disturbance for play area renovations exceeds 150 sf and therefore does not qualify for an outright exemption. The play area is located more than 50 feet from the edge of the pond (WQR) on the site and is outside the vegetated corridor/buffer area associated with the pond. See next section.

- 9. Routine repair and maintenance, alteration, demolition, and/or change of use of existing legal structures, provided that the following criteria are met:
  - a. There is no change in the location, or increase in the footprint, of any building, impervious surface, or outdoor storage area within a WQR or HCA.

**Response:** The current 344 sf amphitheater stage will be removed and repayed to have a footprint of 263 sf using pervious payement. The location will remain the same. Therefore, this activity is exempt.

b. No other site changes are proposed that could result in increased direct stormwater discharges to a WQR. If the project will result in increased direct stormwater discharges, the proposal is subject to the Type II review process and the standards for discretionary review established in Subsection 19.402.12.

Response: Per the Stormwater Drainage Report (attached), the site has been configured to utilize the existing stormwater basin on the site to catch any new runoff from the site; therefore there will not be an increase in direct stormwater discharges into the WQR. The existing planter will be expanded to accommodate the new development. In addition, pathways within the WQR buffer area will be replaced with new pathways constructed of pervious materials which will reduce drainage to the WQR in comparison to existing conditions.

#### 19.402.4.B. Limited Exemptions Within HCAs

The following activities within HCAs are exempt from the provisions of Section 19.402, except that a construction management plan is required, according to the provisions of Subsection 19.402.9, where the activity disturbs a total of more than 150 sq ft:

2. Minor encroachments, not to exceed 500 sq ft for residential zones or 150 sq ft in nonresidential zones, for new features such as accessory buildings, patios, walkways, or retaining walls.

**Response:** Seating will be added to the pathway overlooking the pond and amphitheater area, totaling an area of 15 sf of pervious pavement. Retaining walls equaling less than 150 sf will also be installed within the HCA. This qualifies for a limited exemption.

4. Low-impact outdoor recreation facilities for public use—including, but not limited to, multiuse paths, accessways, trails, picnic areas, or interpretive and educational displays and overlooks that include benches and outdoor furniture—provided that such facilities contain no more than 500 sq ft of new impervious surface. Any trails shall have a maximum width of 5 ft and shall be constructed using nonhazardous, pervious materials.

Response: The play area is considered an outdoor recreational facility for public use, similar to the other types of recreational facilities described in this section of the code. The play area will include play equipment and benches and will encroach a total of 296 sq ft into the HCA. The play area will be covered with pervious rubber play tile surfacing. A total of 424 sf of impervious pathway will be removed within the site and new pathways will constitute 1,481 sf of new pervious surface within the HCA. These recreational facilities will not include the installation of more than 500 sf of impervious surfaces within the HCA and are otherwise low-impact facilities; therefore, these improvements qualify for a limited exemption.

Within the WQRA, disturbance will include removal of 898 sf of impervious pathway, coupled with installation of 1,530 sf of new pervious pathway and installation of two benches which total approximately 15 sf of impervious surface. As a result, less than 150 sf of impervious surfaces will be added within the WQRA.

Although the proposed activities qualify as limited exemptions, they exceed 150 sf and therefore, a construction management plan is required. However, the proposed activities are exempt from other provisions of Section 19.402 per the code language above and as described in subsequent Subsections of this narrative.

#### 19.402.6 Activities Requiring Type I Review

Within either WQRs or HCAs, the following activities and items are subject to Type I review per Section 19.1004:

- A. Limited Tree Removal
  - 1. The Planning Manager may approve an application for limited tree removal or major pruning within WQRs and HCAs when the applicable requirements in Chapter 16.32 are met, except where exempted by Subsection 19.402.6.A.2, under any of the following circumstances:
    - b. The tree is dead, diseased, or dying and cannot be saved, as determined and documented in a report by a certified arborist.

**Response:** The removal of Tree 111 which has been identified as diseased or dead per review by a registered arborist will require a Type I review process per Section 19.402.6.A.1.b. The remainder of the activities within the HCA on the site are exempt or qualify for limited exemptions and will be reviewed and addressed via the Construction Management Plan provisions in responses to Subsection 19.402.9.

#### 19.402.11 Development Standards

#### 19.402.11.A Protection of Natural Resources During Site Development

During development of any site containing a designated natural resource, the following standards shall apply:

- 1. Work areas shall be marked to reduce potential damage to the WQR and/or HCA.
- 2. Trees in WQRs or HCAs shall not be used as anchors for stabilizing construction equipment.
- 3. Native soils disturbed during development shall be conserved on the property.

- 4. An erosion and sediment control plan is required and shall be prepared in compliance with requirements set forth in the City's Public Works Standards.
- 5. Site preparation and construction practices shall be followed that prevent drainage of hazardous materials or erosion, pollution, or sedimentation to any WQR adjacent to the project area.
- 6. Stormwater flows that result from proposed development within and to natural drainage courses shall not exceed predevelopment flows.
- 7. Prior to construction, the WQR and/or HCA that is to remain undeveloped shall be flagged, fenced, or otherwise marked and shall remain undisturbed. Such markings shall be maintained until construction is complete.
- 8. The construction phase of the development shall be done in such a manner as to safeguard the resource portions of the site that have not been approved for development.
- 9. Where practicable, lights shall be placed so that they do not shine directly into any WQR and/or HCA location. The type, size, and intensity of lighting shall be selected so that impacts to habitat functions are minimized.
- 10. All work on the property shall conform to a construction management plan prepared according to Subsection 19.402.9.
- 11. The applicable provisions of Chapter 16.32 shall be met.

**Response:** Sheet C3.01 of Exhibit A shows the Erosion Control Plan for the site and how the project will meet all of the provisions of 19.402.11.A. Per Sheet C3.01, all erosion prevention measures shall be in place, functional, and approved in accordance with the approved erosion prevention and sediment control plan prior to commencement of construction activities. Sediment control fencing, inlet protection, and tree protection fencing will be placed as shown on Sheet C3.01.

All soil disturbing and construction activities shall be conducted in accordance with MMC Chapter 16.28 erosion control and any applicable local, state or federal requirements as shown in notations on Sheet C3.01 of Exhibit A.

Alternative sediment controls must provide a discharge that is clean and free of sediment, surfactants, and other pollutants prior to entering the storm system. Approval of alternative sediment controls by the City of Milwaukie wastewater division manager is required prior to installation.

Written spill prevention and response procedures shall be developed, maintained, and implemented on the construction site. Dumping or disposal of spoil materials into any stream corridor, wetlands, surface waters or on any public or private property not specified for said purpose is prohibited. Sediment and pollutants shall not be washed into storm sewers, drainage ways, or water bodies. Dry sweeping shall be implemented to clean up construction areas to prevent release of sediments into the storm system. 6Disposal of sediment laden water into the wastewater system is prohibited unless prior written approval is received from the City of Milwaukie wastewater division manager. Sediment laden water shall be pumped through an approved sediment control BMP prior to disposal into the wastewater system.

Sawcutting slurry and debris shall be vacuumed and removed from all impervious surfaces. Vacuumed sawcutting slurry shall be properly disposed of and not discharged into the storm system.

Watertight trucks shall be used to transport saturated soils from the construction site.

Temporary stabilization and covering of soil stockpiles shall occur at the end of each workday.

All toxic or hazardous materials shall be properly stored, applied, and disposed.

An area shall be designated for washing out concrete trucks such that runoff from washing activities are contained and do not leave the site or enter the storm system. Sweepings from exposed aggregate concrete shall not be washed to the street or storm system. Sweepings shall be collected and properly disposed of in the trash.

Paving in wet weather when paving chemicals can runoff into the storm system is prohibited. Tracking of dirt and debris onto impervious surfaces, such as streets and parking lots, is prohibited. Impervious surfaces shall be kept free of dirt and debris at all times if it can be spread by traffic or can enter the storm system.

Gravel or dirt curb ramps are prohibited. Only wood step style curb ramps are allowed. Upon completion of site restoration and approval from the City of Milwaukie engineering director, all temporary erosion control measures may be removed. Drainage from springs or groundwater must be addressed during construction by the contractor. Discharge from groundwater encountered on the site must be clean of sediment or pollutants.

Areas subject to wind erosion shall use appropriate dust control measures including the application of a fine spray of water, plastic sheeting, straw mulch, or other approved measures. Dates of implementation of wet weather measures are October 1st to April 30th.

Materials shall not be stockpiled on public streets or in the right of way for longer than immediate use.

All of the above practices and requirements are noted on Sheet C3.01. As a result, these requirements will be met.

Additionally, per the Stormwater Drainage Report (attached), stormwater will drain into the existing basin on the site that will be expanded in order to accommodate treatment of any new flows. This meets standard 19.402.11.A.6.

#### 19.402.11.B General Standards for Required Mitigation

**Response:** Per the responses for section 19.402.4, the development on this site is considered exempt or meets the requirements for limited exemptions; therefore, the mitigation standards for Section 19.402.11.B do not apply to this project.

#### 19.402.11.C Mitigation Required for Disturbance with WQRs

**Response:** Per the responses for section 19.402.4, no activities are proposed within a WQR area; therefore the mitigation standards for Section 19.402.11.C do not apply to this project.

#### 19.402.11.D Nondiscretionary Standards for HCAs

**Response:** Per the responses for section 19.402.4, proposed disturbances within the HCA qualify as outright or limited exemptions and therefore do no count towards the amount of disturbance area per Subsection 19.402.11.D.1.c. In addition, no residential structures are proposed as part of this project so Subsection 19.402.11.D.1.a is not applicable. As a result, the mitigation standards for disturbance to HCAs in Subsection 19.402.11.D.2 do not apply to this project.

#### 19.402.11.E Standards for Special Uses

**Response:** Per the responses for section 19.402.4, proposed disturbances within the HCA qualify as outright or limited exemptions. As a result, the standards in Subsection 19.402.11.E do not apply to this project.

#### 19.402.9 Construction Management Plans

- A. Construction management plans are not subject to Type I review per Section 19.1004 but shall be reviewed in similar fashion to an erosion control permit (MMC Chapter 16.28).
- B. Construction management plans shall provide the following information:
  - 1. Description of work to be done.
  - 2. Scaled site plan showing a demarcation of WQRs and HCAs and the location of excavation areas for building foundations, utilities, stormwater facilities, etc.
  - 3. Location of site access and egress that construction equipment will use.
  - 4. Equipment and material staging and stockpile areas.
  - 5. Erosion and sediment control measures.
  - 6. Measures to protect trees and other vegetation located within the potentially affected WQR and/or HCA. Tree protection must be consistent with the requirements in Section 16.32.042.F.

When required for a property that does not include a designated natural resource, the construction management plan shall show the protective measures that will be established on the applicant's property.

**Response:** This application includes all of the required information for a Construction Management Plan as described below; as a result, standards of 19.402.9 are met.

1. Description of work to be done.

This information is found in the introductory narrative included in this application and is further detailed in the supporting plan sets (Exhibit A).

2. Scaled site plan showing a demarcation of WQRs and HCAs and the location of excavation areas for building foundations, utilities, stormwater facilities, etc.

This information is found on Sheet L3.01 of Exhibit A and Sheet L4.01 of Exhibit B.

3. Location of site access and egress that construction equipment will use.

This information is found on Sheet C3.01 of Exhibit C.

4. Equipment and material staging and stockpile areas.

This information is found on Sheet C3.01 of Exhibit C.

5. Erosion and sediment control measures.

This information is found on Sheet C3.01 of Exhibit A.

6. Measures to protect trees and other vegetation located within the potentially affected WQR and/or HCA. Tree protection must be consistent with the requirements in Section 16.32.042.F.

This information is found on Sheet L2.01 of Exhibit A.

#### 19.402.15 Boundary Verification and Map Administration

The NR Administrative Map shows the locations of WQRs and HCAs. For WQRs, the NR Administrative Map is a general indicator of protected water features and their associated vegetated corridors; the location of actual WQRs is determined according to the parameters established in Table 19.402.15. With respect to HCA locations, the NR Administrative Map is assumed to be correct unless demonstrated otherwise.

#### A. Boundary Verification

To determine whether the standards of Section 19.402 apply to a proposed activity at any given location, the boundaries of any designated natural resource(s) on or near the site shall be verified.

Agreement with the accuracy of the NR Administrative Map does not constitute or require a land use decision. However, for activities proposed within 100 ft of a wetland or its associated vegetated corridor, the boundary verification process outlined in Subsection 19.402.15.A.2.a(1)(b) shall be followed to identify the specific location of wetlands on the subject property. The Planning Director may waive the requirement for official wetland delineation, depending on the specific circumstances of the site and the proposed activity. Such circumstances may include, but are not limited to, the scale and potential impacts of the proposed activity, the proximity of the proposed activity to the mapped resource, and the Director's confidence in the accuracy of the NR Administrative Map relative to the resource in question.

Response: The site includes a constructed pond associated with Spring Creek. The water levels in the pond are typically highly controlled and are subject to very little fluctuation. The portion of the pond on the Scott Park site has not undergone a wetland delineation. The National Wetlands Inventory identifies the pond as fresh water and does not indicate any wetlands on the site. The boundary of the pond which qualifies as a water quality resource was originally mapped by Metro through the Metro Streams (line) data. Metro's data source was US Geological Survey (USGS) 7.5 minute quadrangles. That data was generated after completion of the last major work in Scott Park.

In addition, the City's consultants (KPFF) surveyed the edge of pond in March, 2023. The surveyed edge of the pond is shown on Exhibit A. While the City lacks the necessary data to confirm that this boundary constitutes the top of bank or ordinary high water mark (OHWM) associated with the pond, the City believes that the surveyed boundary closely approximates the OHWM, given minimal fluctuations in water levels of the pond. Based on discussions with City staff (Adam Moore), GreenWorks' project manager and wetland scientist Jennifer D'Avanzo, and DSL Jurisdictional Coordinator Chris Stevenson, City and DLS staff determined that no wetland delineation or wetland permit was necessary as part of this project and also determined that all proposed improvements at Scott Park work are above the ordinary high water mark. It also should be noted that the two boundary lines (WQR line and KPFF-surveyed water edge) are in quite close proximity to each other, with one boundary closer to the proposed improvements in Scott Park in some cases, and the other closer in other cases.

To be conservative, the City proposes to use the larger boundary as the identified boundary for the vegetated corridor buffer associated with the WQR (i.e., the WQRA) for purposes of evaluating disturbance within and potential impacts to the WQRA. The City also requests that the Planning Director waive the requirement for a delineation of the pond boundaries, given the proposed conservative approach described here, the nature of the resource, and the fact that proposed disturbance within the WQRA is minimal. In addition, as noted in previous sections of this narrative, the City is planting a significant amount of native vegetation on the site (one tree and approximately 40 shrubs). While mitigation is not required for disturbance in the WQRA and HCA areas on the site, given that all proposed improvements qualify as exemptions or limited exemptions, this level of planting would be equivalent to mitigation of approximately 850 square feet of non-exempt disturbance in terms of the number of shrubs planted.

Pending a decision to waive the requirement for a delineation of the pond boundary, the requirements of this section of the code.

#### 4. Other Standards

#### 19.508.4.G Open Space/Plazas

**Response:** These standards are for mixed-use residential development and therefore do not apply to the park development on this site.

#### 14.16.060 Signs

No sign shall be installed or maintained in the DMU or OS Zones, except as allowed under Section 14.12.010 Exempted Signs, or as otherwise noted in this section.

#### A. Freestanding Sign

In the downtown zones, freestanding signs shall be monument type only. The sign face shall be no less than 60% of the total area of the monument. Pole signs are prohibited.

1. Area

The maximum permitted display surface area of a freestanding sign shall be computed on 1 sq ft of area per lineal ft of street or highway frontage.

- a. In the OS Zone the maximum area shall not exceed 32 sq ft per display surface and 64 sq ft overall.
- 2. Height and/or Clearance
  - a. In the DMU Zone, freestanding signs are limited to a maximum height of 7 ft. Properties with frontage on McLoughlin Blvd may have freestanding signs with a maximum height of 15 ft and shall only be located along the McLoughlin Blvd frontage. Freestanding sign height shall be measured from the top of the sign to the lowest finished grade within a 6-ft horizontal distance from the sign.
  - b. In the OS Zone freestanding signs are limited to a maximum height of 6 ft above grade.

#### 3. Number

One freestanding sign is permitted on a street or highway frontage.

**Response:** Per Sheet L4.01, one park sign is planned for the site. Per Sheet L28.02, the sign will be a freestanding sign that measures 36 inches high by 48 inches wide, with a total display area of 12 square feet, which is less than the allowed maximum area and lower than the allowed maximum height. The sign panel will be the standard Milwaukie parks sign. All sign standards are met.

#### 5. Site Development Review – Approval Criteria

A. The proposal complies with all applicable base zone standards in Chapter 19.300.

**Response:** As shown in Sections 2 and 3 of this application, all base zone standards for the Open Space zone are met; therefore this criterion is achieved.

B. The proposal complies with all applicable overlay zone and special area standards in Chapter 19.400.

**Response:** As shown in Section 4 of this application, all development standards for the Natural Resource overlay are met; therefore, this criterion is achieved.

C. The proposal complies with all applicable supplementary development regulations in Chapter 19.500.

**Response:** Per Table 19.304.2, there are no supplementary development regulations for this site; therefore, this approval criterion is not applicable.

D. The proposal complies with all applicable off-street parking and loading standards and requirements in Chapter 19.600.

**Response:** The site and proposed project represent a nonresidential use in the OS Zone, for which there are no off-street parking requirements; therefore, this criterion is met.

E. The proposal complies with all applicable public facility standards and requirements, including any required street improvements, in Chapter 19.700.

**Response:** Per Subsection 19.702.1 – Applicability, this project is not subject to the requirements of Chapter 19.700; therefore, this criterion is not applicable.

F. The proposal complies with all applicable conditions of any land use approvals for the proposal issued prior to or concurrent with the development review application. (Ord. 2161 § 2, 2018; Ord. 2036 § 3, 2011; Ord. 2025 § 2, 2011)


**Response:** As discussed in the pre-application process, this project is subject to a Natural Resource Review process. As demonstrated in Section 4 of this application, all applicable conditions of that review are met. Therefore, this criterion is achieved.

**Scott Park Application** 

Exhibit A – 30% Design Drawings


**Scott Park Application** 

Exhibit B – Materials Plan

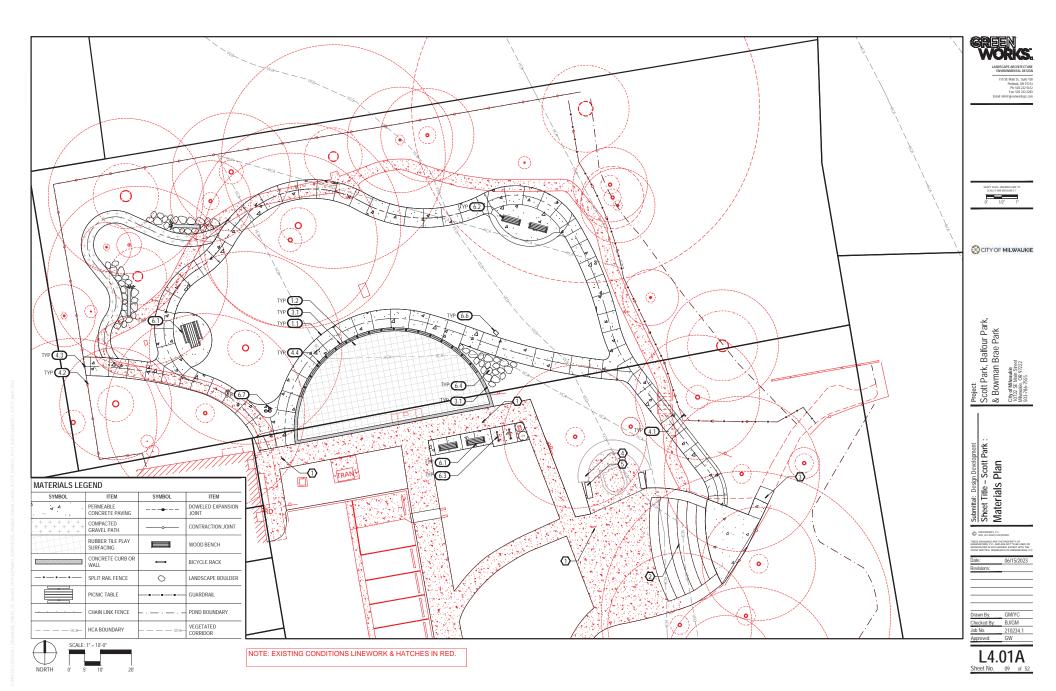

**Scott Park Application** 

Exhibit C – Erosion Control and Construction Plan

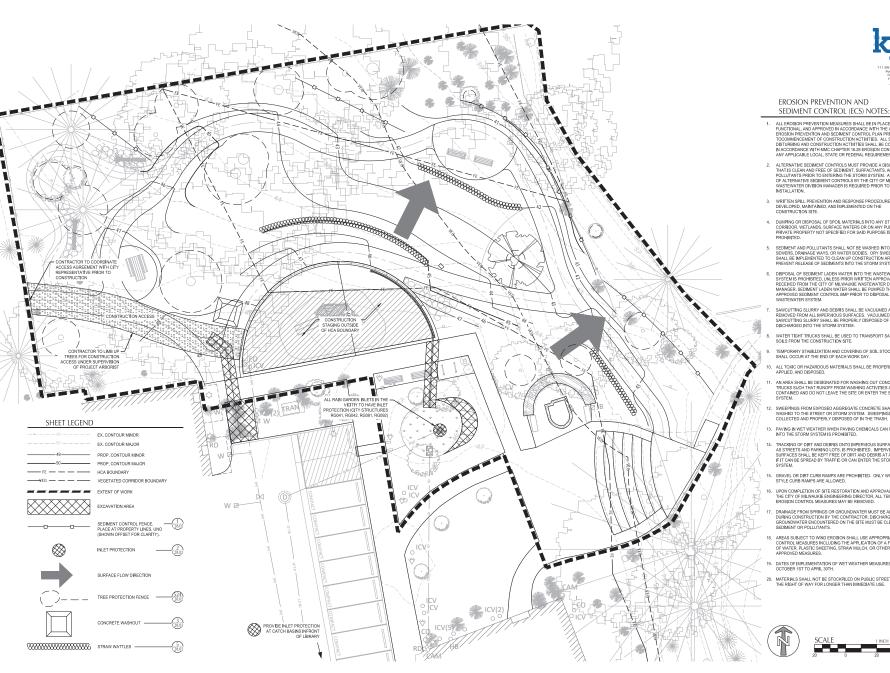



#### EROSION PREVENTION AND

- ALL EROSION PREVENTION MEASURES SHALL BE IN PLACE, FUNCTIONAL, AND APPROVED IN ACCORDANCE WITH THE APPROVED ROSIGN PREVENTION AND SEDIMENT CONTROL, PLAN PRIOR TOCOMBENCEMENT OF CONSTRUCTION ACTIVITIES. ALL SOIL DISTURBING AND CONSTRUCTION ACTIVITIES. ALL SOIL DISTURBING AND CONSTRUCTION CONTROL STATE OF CONDUCTED IN ACCORDANCE WITH MICE CHAPTER 18.28 EROSION CONTROL AND ANY APPLICABLE COLOG., STATE OF REPERAL REQUIREMENTS.
- 2. ALTERNATIVE SEDIMENT CONTROLS MUST PROVIDE A DISCHARGE AL LERNAI IP: SEDIMENT CONTROLS MUST PROVIDE A DISCHARGE THAT IS CLEAN AND FREE OF SEDIMENT, SURFACTANTS, AND OTHER POLLUTANTS PRIOR TO ENTERING THE STORM SYSTEM. APPROVAL OF ALTERNATIVE SEDIMENT CONTROLS BY THE CITY OF MUNAUAIGE WASTEWATER DIVISION MANAGER IS REQUIRED PRIOR TO INSTALLATION.
- WRITTEN SPILL PREVENTION AND RESPONSE PROCEDURES SHALL BE DEVELOPED, MAINTAINED, AND IMPLEMENTED ON THE CONSTRUCTION SITE.
- DUMPING OR DISPOSAL OF SPOIL MATERIALS INTO ANY STREAM CORRIDOR, WETLANDS, SURFACE WATERS OR ON ANY PUBLIC OR PRIVATE PROPERTY NOT SPECIFIED FOR SAID PURPOSE IS PROHIBITED.
- SEDIMENT AND POLLUTANTS SHALL NOT BE WASHED INTO STORM SEVERS, DRAINAGE WAYS, OR WATER BODIES. DRY SWEEPING SHALL BE IMPLEMENTED TO CLEAN UP CONSTRUCTION AREAS TO PREVENT RELEASE OF SEDIMENTS INTO THE STORM SYSTEM.
- 6. DISPOSAL OF SEDMENT LAGEN WATER INTO THE WASTEWATER SYSTEM IS PROHIBITED, UNLESS PRIOR WRITTEN APPROVAL IS RECEIVED FROM THE CITY OF MUNAULKE WASTEWATER DIVISION MANAGER. SEDMENT LAGEN WATER SHALL BE PUMPED THROUGH AN APPROVED SEDMENT CONTROL BMIP PRIOR TO DISPOSAL INTO THE WASTEMATER SYSTEM.
- SAWCUTTING SLURRY AND DEBRIS SHALL BE VACUUMED AND REMOVED FROM ALL IMPERVIOUS SURFACES. VACUUMED SAWCUTTING SLURRY SHALL BE PROPERLY DISPOSED OF AND NOT DISCHARGED INTO THE STORM SYSTEM.
- WATER TIGHT TRUCKS SHALL BE USED TO TRANSPORT SATURATED SOILS FROM THE CONSTRUCTION SITE.
- ALL TOXIC OR HAZARDOUS MATERIALS SHALL BE PROPERLY STORED, APPLIED, AND DISPOSED.
- AN AREA SHALL BE DESIGNATED FOR WASHING OUT CONCRETE TRUCKS SUCH THAT RUNOFF FROM WASHING ACTIVITIES ARE CONTAINED AND DO NOT LEAVE THE SITE OR ENTER THE STORM SYSTEM.
- SWEEPINGS FROM EXPOSED AGGREGATE CONCRETE SHALL NOT BE WASHED TO THE STREET OR STORM SYSTEM. SWEEPINGS SHALL BE COLLECTED AND PROPERLY DISPOSED OF IN THE TRASH.
- 13. PAVING IN WET WEATHER WHEN PAVING CHEMICALS CAN RUNOFF
- TRACKING OF DIRT AND DEBRIS ONTO IMPERVIOUS SURFACES, SUCH AS STREETS AND PARKING LOTS, IS PROHIBITED. IMPERVIOUS SURFACES SHALL BE KEPT FREE OF DIRT AND DEBRIS AT ALL TIMES IF IT CAN BE SPREAD BY TRAFFIC OR CAN ENTER THE STORM SYSTEM.
- GRAVEL OR DIRT CURB RAMPS ARE PROHIBITED. ONLY WOOD STEP STYLE CURB RAMPS ARE ALLOWED.
- 16. UPON COMPLETION OF SITE RESTORATION AND APPROVAL FROM THE CITY OF MILWAUKIE ENGINEERING DIRECTOR, ALL TEMPORARY EROSION CONTROL MEASURES MAY BE REMOVED.
- DRAINAGE FROM SPRINGS OR GROUNDWATER MUST BE ADDRESSED DURING CONSTRUCTION BY THE CONTRACTOR. DISCHARGE FROM GROUNDWATER ROCUNTERED ON THE SITE MUST BE CLEAN OF SEDIMENT OR POLLUTANTS.
- 18. AREAS SUBJECT TO WIND EROSION SHALL USE APPROPRIATE DUST CONTROL MEASURES INCLUDING THE APPLICATION OF A FINE SPRAY OF WATER, PLASTIC SHEETING, STRAW MULCH, OR OTHER APPROVED MEASURES.
- DATES OF IMPLEMENTATION OF WET WEATHER MEASURES ARE OCTOBER 1ST TO APRIL 30TH.
- MATERIALS SHALL NOT BE STOCKPILED ON PUBLIC STREETS OR IN THE RIGHT OF WAY FOR LONGER THAN IMMEDIATE USE.







CITY OF MILWAUKIE

Project: Scott Park, Balfour Park, & Bowman Brae Park City of Milwaukie 10722 SE Main Street Milwaukie, OR 97222 503-786-7555

Submittai: Design Development
Sheet Title - Scott Park:
CONSTRUCTION
ACCESS & EROSION
CONTROL PLAN

© GREENWORKS, P.C.

Drawn By: CK/RC Checked By: JZ Job No. 210234.1

C3.01 Sheet No.

**Scott Park Application** 


Exhibit D – Stormwater Drainage Report – Scott, Bowman-Brae and Balfour Parks SCOTT PARK: LOCATED AT 10660 SE 21ST AVE. AND DEFINED BY LEDDING LIBRARY TO THE SOUTH, POND TO THE EAST AND ADJACENT DEVELOPMENTS AND PARKING AREAS TO THE NORTH AND WEST. TOTAL SITE AREA IS 20,400 SF. THE EXISTING PATH AND PART OF THE LAWN WILL BE DEMOLISHED FOR THE PLANNED SITE FEATURES, WHICH INCLUDE A PLAY AREA, WALKING TRAILS, POND OVERLOOK AND OTHER AMENITIES. THE EXISTING PARKING, SIDEWALK, AMPHITHEATER AND WAR MEMORIAL WILL REMAIN.

BALFOUR PARK: LOCATED AT 3039 SE BALFOUR ST. AND DEFINED BY SE BALFOUR ST TO THE SOUTH, AND RESIDENTIAL PROPERTIES TO THE EAST, WEST AND NORTH. THE TOTAL SITE AREA IS 35,600 SF. LOW-IMPACT CLEARING AND REGRADING, AND SELECTIVE TREE REMOVAL WILL ALLOW FOR PROPOSED PARK FEATURES, WHICH INCLUDE A PLAY AREA, NATURE PLAY FEATURES, WALKING TRAILS, A SHELTER AND OTHER AMENITIES.

BOWMAN BRAE PARK: LOCATED AT 4267 SE BOWMAN ST. AND DEFINED BY SE BOWMAN ST TO THE SOUTH, PRIVATE DRIVE TO THE EAST AND ADJACENT RESIDENTIAL PROPERTIES TO THE NORTH AND WEST. TOTAL SITE AREA IS 30,000 SF. CLEARING AND REGRADING, AND SELECTIVE TREE REMOVAL WILL ALLOW FOR PROPOSED PARK FEATURES, WHICH INCLUDE A PLAY AREA, WALKING TRAILS, A SHELTER AND OTHER AMENITIES.

#### **VICINITY MAPS**



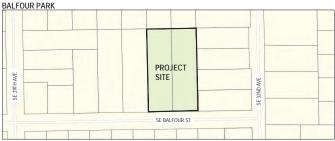



## Scott Park, Balfour Park, & Bowman Brae Park

Milwaukie, OR 97222

## Frae Park MORE M

LANDSCAPE ARCHITECTURE ENVIRONMENTAL DESIGN 110 SE Main St., Suite 100 Portland, OR 97214 Ph: 503 222 5612 Fax: 503 222 283 Email: Infolligeconverkey.com

CITY OF MILWAUKIE

#### SHEET INDEX

SHEET#	SHEET TITLE	SHEET COUNT	SHEET #	SHEET TITLE	SHEET COUNT
ALL PARKS					
G0.00	COVER SHEET & SHEET INDEX	01	C22.00	UTILITY PLAN	34
G0.01	GENERAL NOTES AND ABBREVIATIONS	02	C22.01	FRONTAGE IMPROVEMENTS	35
			C22.02	EROSION CONTROL PLAN AND DETAILS	36
SCOTT PARK	(				
L1.01	EXISTING CONDITIONS PLAN	03	L22.01	MATERIALS NOTES	37
L2.01	TREE PROTECTION PLAN	04	L22.01	MATERIALS PLAN	38
L3.01	DEMOLITION PLAN	05	L23.01	LAYOUT PLAN	39
			L24.01	GRADING PLAN	40
C3.00	UTILITY PLAN	06	L25.00	IRRIGATION SCHEDULE AND NOTES	41
C3.01	EROSION CONTROL PLAN AND DETAILS	07	L25.01	IRRIGATION PLAN	42
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L21.01	DEMOLITION PLAN	33			

#### PROJECT DIRECTORY

CITY OF MILWAUKIE 10722 SE MAIN ST MILWAUKIE, OR 97222 PROJECT CONTACT: Adam Moore PHONE: 503-786-7624 EMAIL: moore@milwaukiegregon.go

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TIO SE MAIN ST, SUITE 100
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PHONE: 503-222-5612
EMAIL: benj@greenworkspc.com

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#### SITE SURVEY

PROFILAND, OR 97204
PROJECT CONTACT: John R. Davis
PHONE: 503-542-3860
EMAIL: john.davis@kpff.com

#### ARBORIST

TERAGAN & ASSOCIATES 3145 WESTVIEW CIRCLE LAKE OSWEGO, OR 97034 PROJECT CONTACT: Terrence P. Flanagan PHONE: 503-697-1975 EMAIL: terry@teradan.com

Drawn By:	GM/Y
Checked By:	B I/GN

G0.00 Sheet No. 01 of 52

**SUBMITTAL** 

30% CONSTRUCTION DOCUMENTS ISSUE DATE: APRIL 11, 2023 REVISION DATE:

#### GENERAL NOTES

- ALL WORK PERFORMED IN CONNECTION WITH THE CONTRACT DOCUMENTS, INCLUDING MATERIALS FURNISHED, WORKMANSHIP, AND MEANS AND METHODS OF CONSTRUCTION SHALL CONFORM TO THE LATEST STANDARDS, PRACTICES AND REQUIREMENTS OF THE APPLICABLE FEDERAL, STATE AND LOCAL AUTHORITES.
- 2. IT SHALL BE THE RESPONSIBILITY OF THE CONTRACTOR TO VERIFY ALL UTILITY LOCATIONS. DEPTHS AND ELEVATIONS PRIOR TO CONSTRUCTION AND ARRANGE FOR THE RELOCATION OF ANY INCOMPLICT WITH ALL CONSTRUCTION ACTIVITIES. THE LOCATIONS AND DESTRUCTION OF UTILITIES WITH THIS DOCUMENT IS FOR INFORMATION ONLY AND IS NOT GUARANTEED TO BE ACCUPATE. ANY DISCREPANCIES BETWEEN SURVEY INFORMATION AND FIELD CONDITIONS SHALL BE REPOWER! TO SHE THE OWNERS REPRESENTATIVE MINEDIATELY.
- IT SHALL BE UNDERSTOOD THAT THE IMPROVEMENTS SHOWN ON THE DRAWINGS AND SPECIFICATIONS ARE MEANT TO COMPLY WITH ALL APPLICABLE CODES AND ORDINANCES. MODIFICATIONS, COMPLICTS, OR ISSUES THAT ARRSE THAT WOULD CONTRADICT RELEVANT CODES AND ORDINANCES SHALL BE BROUGHT OF THE ATTENTION OF THE OWNERS REPRESENTATIVE IMMEDIATELY.
- 4. COMPLY WITH ORECON LAW REQUIRING ADHERENCE TO THE RULES ADDPTED BY THE ORECON UTILITY NOTIFICATION CENTER. NOTIFY THE ORECON UTILITY NOTIFICATION CENTER AT LEAST 2 BUSINESS DAYS, BUT NOM MORE THAN 10 BUSINESS DAYS, BUT NOTIFICATION CENTER AT LEAST 2 BUSINESS DAYS, BUT NOMER THAN 10 BUSINESS DAYS, BEFORE COMMENCING EXCAMPTION, THOSE RULES ARE SET FORTH IN QAR 952,001.001 THEOUGH OAR 952.001.0090 AND ORS 757.541 TO 757.57. PHONE CONTACT FOR THE OREGON UTILITY NOTIFICATION OF THE PS 13 -803-23-244 for \$111.
- 5. REPAIR AT OWN EXPENSE ANY DAMAGE DONE TO UTILITY SYSTEMS, SURFACE PAVEMENTS, SITE FEATURES, AND STRUCTURES, WHETHER INSIDE OR OUTSIDE OF THE PROJECT LIMITS, THAT ARE NOT DIRECTLY INDICATED TO BE REMOVED OR RELOCATED AS PART OF THE PROJECT CONSTRUCTION.
- 6. ALL QUANTITIES SHOWN ON THE DRAWINGS OR SPECIFICATIONS ARE FOR CONVENIENCE ONLY.
- . UPON PROJECT COMPLETION, THE PROJECT AREA AND ADJACENT SPACES SHALL BE FREE AND CLEAR OF ALL CONSTRUCTION MATERIALS, WASTE AND DEBBIS. CONTRACTOR SHALL REMOVE AND PROPERLY DISPOSE OF ALL MATERIALS AS INDICATED IN THE PROJECT CONTRACT DOCUMENTS AND MUST MEET ALL APPLICABLE REGULATIONS OVERSEEINED WASTE DISPOSED.

#### **GENERAL LEGEND**

W M WATER METER

OLIVLIN	AL LLULIND		
SYMBOL	ITEM	SYMBOL	ITEM
19	FD. MONUMENT AS NOTED	17//	BUILDING OUTLINE WITH DOOR
-	SIGN		CONCRETE SURFACE
o <sup>B</sup>	BOLLARD		ASPHALT SURFACE
000	BIKE RACK	<i>111 1111 11</i>	WALL
<b>o</b> RD	ROOF DRAIN		BUILDING OVERHANG
<b>Ø</b> ./B	ELECTRICAL JUNCTION BOX		CURB LINE
E 🛭	ELECTRICAL METER		EDGE OF ASPHALT
EO <b>o</b>	ELECTRICAL OUTLET		ELECTRICAL LINE
DEC	ELECTRICAL CABINET		STORM LINE
<b>□</b> ES	ELECTRICAL SWITCH		WATER LINE
EVLT	ELECTRICAL VAULT		EDGE OF WATER
TRAN	TRANSFORMER		CHAIN LINK FENCE
*	LUMINAIRE		WOOD FENCE
*	GROUND FLOOD LIGHT		MAJOR CONTOUR
\$	OVERHEAD LIGHT		MINOR CONTOUR
0	STORM MANHOLE WITH STRUCTURE	0	DECIDUOUS TREE
o <sup>CO</sup>	SANITARY/STORM CLEAN OUT	**	CONIFEROUS TREE
11	SANITARY STORM STRUCTURE	*	SHRUB
M	WATER VALVE	o <sup>HB</sup>	HOSE BIB
-6-	FIRE HYDRANT	o <sup>ICV</sup>	IRRIGATION CONTROL VALVE

▲ #1 PROJECT CONTROL POINT

#### TABLE OF ABBREVIATIONS

NOTE: NOT	ALL ABBREVIATIONS REFERENCED IN DRAWINGS. AB	BREVIATION	NS MAY BE SHOWN WITH OR WITHOUT PERIODS.
@	AT	MIN	MINIMUM
ALUM	ALUMINUM	MH	MANHOLE
APPROX	APPROXIMATE	NIC	NOT IN CONTRACT
ARCH	ARCHITECT	NOM	NOMINAL
AC	ASPHALT CONCRETE	NPS	NOMINAL PIPE SIZE
BC .	BOTTOM OF CURB	NTS	NOT TO SCALE
3&B	BALLED AND BURLAP	OH	OVER HEAD
BLDG	BUILDING	OC	ON CENTER
3M	BENCHMARK	OD	OUTSIDE DIAMETER
BPRD	BEND PARKS & RECREATION DISTRICT	OFCI	OWNER FURNISHED CONTRACTOR INSTALL
BS .	BOTTOM OF STAIR	PA	PLANTING AREA
BR	BOTTOM OF RAMP	PC	POINT OF CURVATURE
WO	BOTTOM OF WALL (ELEV. BELOW FINISH GRADE)	PCC	POINT OF COMPOUND CURVATURE / PORTL
3W	BOTTOM OF WALL (ELEV. AT FINISH GRADE)		CEMENT CONCRETE
B	CATCH BASIN	PI	POINT OF INTERSECTION
CF	CUBIC FEET	PIP	POURED-IN-PLACE
CAL	CALIPER	PL	PLATE
CJ	CONTRACTION JOINT	PLS	PURE LIVE SEED
LR	CLEAR	POT	POINT OF TANGENCY
IP .	CAST-IN-PLACE	PT	PRESSURE TREATED
CONT	CONTAINER / CONTINUOUS	PERF	PERFORATED
CL/E	CENTER LINE	PK	POINT KNOWN
CP	CENTER POINT	PP	POWER POLE
CT	CURRENT TRANSFORMER	PVC	POLYVINYL CHLORIDE PIPE
MIC	DIMENSION	R	RADIUS
AIC	DIAMETER	REF	REFERENCE
EMO	DEMOLISH	REINF	REINFORCED / REINFORCEMENT
MOC	DOMESTIC WATER LINE	REQ'D	REQUIRED
E)	EXISTING	ROW	RIGHT-OF-WAY
Ā	EACH	RP7	ROOT PROTECTION ZONE
	EXPANSION JOINT	RT	RIGHT
I.C.	EXTERIOR LIGHTING CONTROL	SAN	SANITARY
LEV	ELEVATION	SD	STORM DRAIN
NG	ENGINEER	SEC	SECONDARY
OP	EDGE OF PAVEMENT	SIM	SIMILAR
0	EQUAL	SS	SANITARY SEWER
EST	ESTIMATE	SSTI	STAINLESS STEEL
B	FLAT BAR	STA	STATION
D.	FIFLD DRAIN	STD	STANDARD
G	FINISH GRADE	STR	STRUCTURAL
i	FLOW LINE	TD	TRENCH DRAIN
oc.	FACE OF CURB	TEL	TELEPHONE
TG	FOOTING	THK	THICK
SALV	GALVANIZED	TOPO	TOPOGRAPHY
GA.	GALIGE	TC.	TOP OF CURB
SFI	GROUND FAULT INTERRUPTER	TR	TOP OF CORB
GB.	GROUND BREAK	TS	TOP OF STAIR
SND	GROUND	TP7	TREE PROTECTION ZONE
IDG	HOT DIP GALVANIZED	TYP	TYPICAL
IMAC.	HOT MIX ASPHALT CONCRETE	TW	TOP OF WALL
MHMAC.	MINOR HOT MIX ASPHALT CONCRETE	UG	UNDERGROUND
IORIZ	HORIZONTAL	VIF	VERIFY IN FIELD
IDRIZ IP	HIGH POINT	VAR	VARIES
ISS	HOLLOW STRUCTURAL SECTION	VAR	VERTICAL CURVE
)	INSIDE DIAMETER	VOI	VOLUME
F	INVERT ELEVATION	W/	WITH
E NT	INVERT ELEVATION INTERMEDIATE	11/	
NI R	INTERMEDIATE IRON ROD	W/O	WITHOUT
		WM	WATER METER
IT	JOINT	WP	WORK POINT
.T	LEFT	WT	WEIGHT
.F	LINEAR FEET	WWM	WELDED WIRE MESH
_P	LOW POINT	YD	YARD
MAX	MAXIMUM		


#### SYMBOL - LEADER LABEL REFERENCE KEYNOTE DETAIL REFERENCE ELEVATION DETAIL REFERENCE SECTION DETAIL REFERENCE SECTION REFERENCE (WITHIN DETAIL) (X) ELEVATION REFERENCE (WITHIN DETAIL) ENLARGEMENT REFERENCE LINEAR DIMENSION RADIUS DIMENSION ANGLE DIMENSION MATCHLINE SEE SHEET LX.XX SHEET MATCHLINE SCALE: 1" = 10'-0" SCALE BAR NORTH ARROW

REVISION TRIANGLE AND CLOUD

LIMIT OF WORK LINE

SYMBOLS LEGEND

#### SITE DETAIL KEYNOTE SYSTEM LEGEND

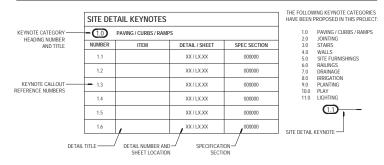





LIMIT OF WORK

Submittat: Design Development
General Legend, Notes,
and Abbreviations

Project: Scott Park, Balfour Park, & Bowman Brae Park

CITY OF MILWAUKIE

SECENTICISES, P.C.

SIZE, ALE RESETS ESSENTED

SEC COMMUNICA ONE THE PROSPECTOR OF

SERVICIONES, P.C., AND ARE NOT TO GE LISTE OR

REPROJECTED IN AN ANAMER, DISCIPLY MINTO THE

CON INTERTION PERMISSION OF GENERAL PLAN

161:

04/11/2023

 Drawn By:
 GM/YC


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 BJ/GM

 Job No.
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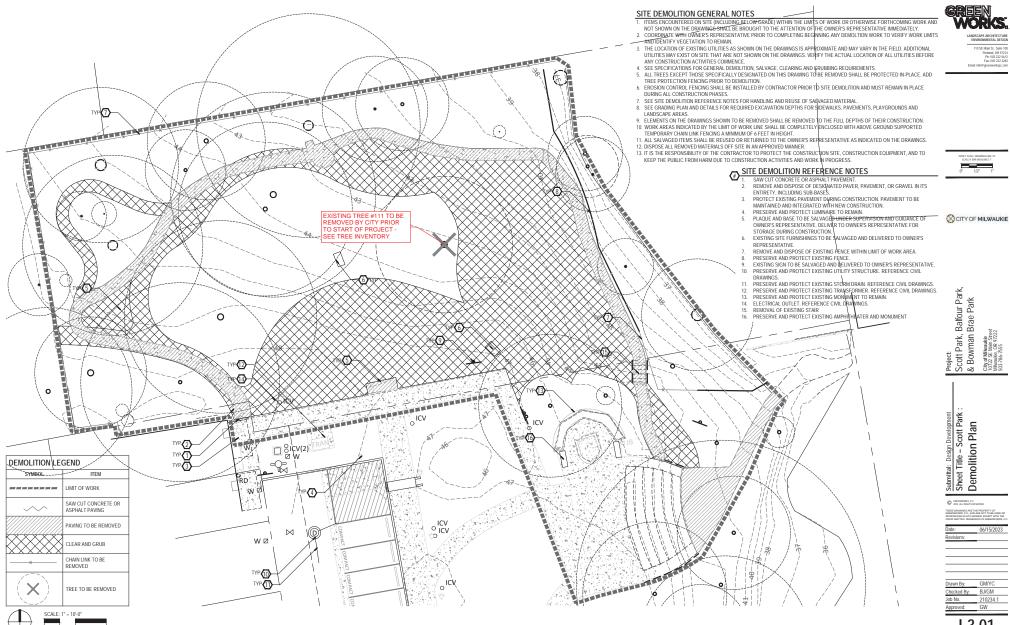
G0.01 Sheet No. 02 of 52




L1.01 Sheet No. 03 of 52

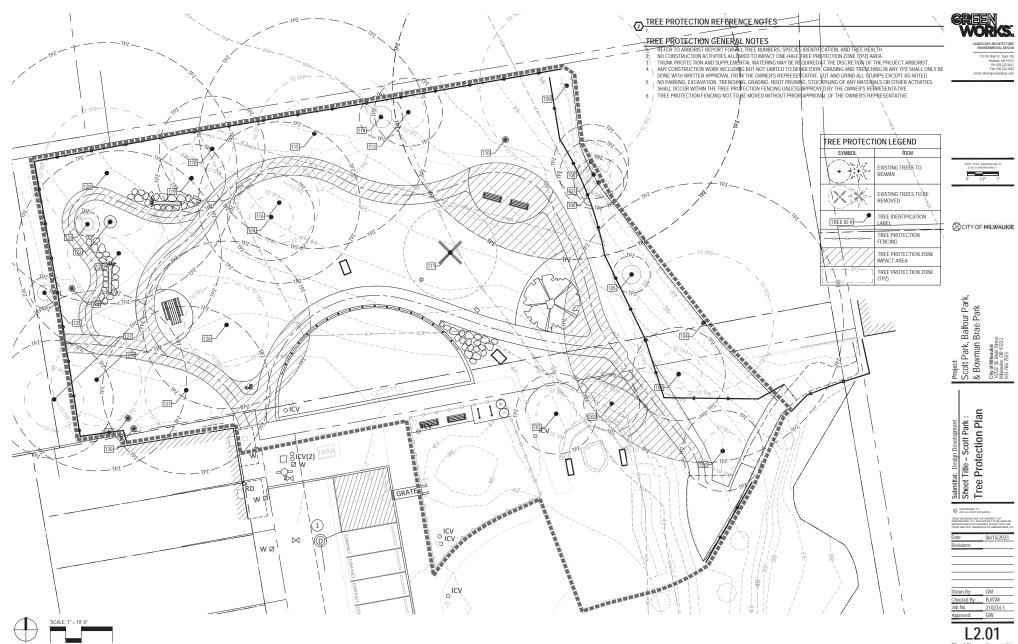

Sheet No. 04 of 52



Sheet No.

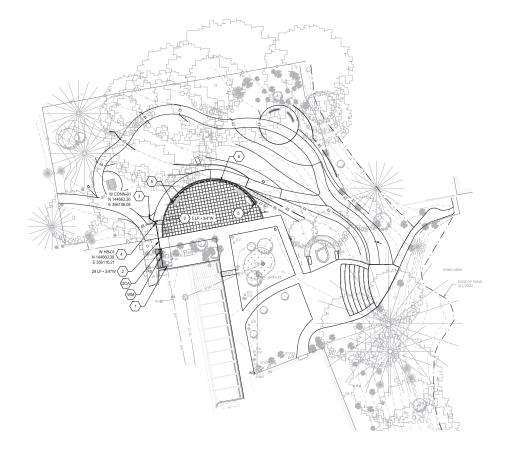





#### SHEET NOTES

- PIPE BEDDING AND BACKFILL FOR ALL UTILITIES PER CITY OF MILWAUKIE STANDARD DETAIL \$10(C28.00.
- 2. STRUCTURES LOCATIONS ARE BASED ON CENTER OF STRUCTURE.
- 3. INSTALL THRUST BLOCK ON WATER LINES PER DETAIL 1/C28.00.

#### 

NOTE DESCRIPTION INSTALL NEW WATER SERVICE CONNECTION TO CITY MAIN. 401/C28.00

INSTALL NEW 3/4" WATER LINE

CONNECT TO WATER FOUNTAIN FEATURE, SEE LANDSCAPING PLANS FOR DETAILS.

INSTALL NEW 45° BEND.

INSTALL 4" PERFORATED DRAINAGE PIPE.

WM INSTALL WATER METER. 401/C28.00 DCA INSTALL DOUBLE CHECK BACKFLOW ASSEMBLY.

!! UTILITY CROSSING, PROVIDE 12" MIN, CLEARANCE, U.N.O. 3/C28.00

#### UTILITY LABEL LEGEND

#### STRUCTURE LABEL

- UTILITY TYPE (SD-STORM DRAINAGE, S-SANITARY SEWER, W=WATER, FP=FIRE PROTECTION) - STRUCTURE TYPE CALLOUT ID NUMBER (WHERE APPLICABLE) N=XXXX.XX LOCATION (WHERE APPLICABLE) RIM:
IE N = XXX
IE OUT = XXX
PIPE LABEL UTILITY LENGTH ----- UTILITY SIZE XXLF - XX\* XX ← UTILITY TYPE 

#### STRUCTURE TYPE

DETAIL REF. 2/C28.00 401/C28.00






Project: Scott Park, Balfour Park, & Bowman Brae Park

Submittal: Design Developr Sheet Title - Scott Park: UTILITY PLAN



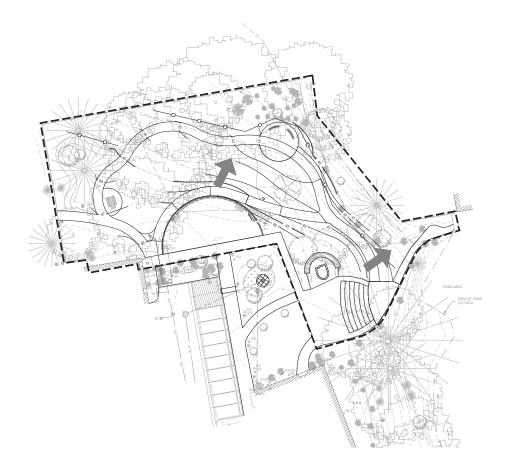





SW Fifth Ave., Suite 2600 Portland, OR 97204 O: 503:542:3860 F: 503:274-4681 www.kpf/.com

#### EROSION PREVENTION AND

- SEDIMENT CONTROL (ECS) NOTES:

  1. ALL EROSION PREVENTION MEASURES SHALL BE IN PLACE, PUNCTIONAL, AND APPROVED IN ACCORDANCE WITH THE APPROVED EROSION PREVENTION AND SEDIMENT CONTROL PLAY INFOIR DOSTUMENTS AND CONSTRUCTION ACTIVITIES SHALL BE CONDUCTED IN ACCORDANCE WITH MING CHAPTER 16.28 BRISSION CONTROL AND ANY APPLICABLE LOCAL STATE OF TEREBRAIL REQUIREMENTS.
- ALTERNATIVE SEDIMENT CONTROLS MUST PROVIDE A DISCHARGE
  THAT IS CLEAN AND FREE OF SEDIMENT, SURFACTAMTS, AND OTHER
  POLLUTANTS PRIOR TO ENTERING THE STORM SYSTEM. APPROVAL
  OF ALTERNATIVE SEDIMENT CONTROLS BY THE CITY OF MILWAUKIE
  WASTEMATER DIVISION MANAGER IS REQUIRED PRIOR TO
  INSTALLATION.
- WRITTEN SPILL PREVENTION AND RESPONSE PROCEDURES SHALL BE DEVELOPED, MAINTAINED, AND IMPLEMENTED ON THE CONSTRUCTION SITE.
- DUMPING OR DISPOSAL OF SPOIL MATERIALS INTO ANY STREAM CORRIDOR, WETLANDS, SURFACE WATERS OR ON ANY PUBLIC OR PRIVATE PROPERTY NOT SPECIFIED FOR SAID PURPOSE IS PROHIBITED.
- SEDIMENT AND POLLUTANTS SHALL NOT BE WASHED INTO STORM SEWERS, DRAINAGE WAYS, OR WATER BODIES. DRY SWEEPING SHALL BE IMPLEMENTED TO CLEAN UP CONSTRUCTION AREAS TO PREVENT RELEASE OF SEDIMENTS INTO THE STORM SYSTEM.
- 6. DISPOSAL OF SEDIMENT LADEN WATER INTO THE WASTEWATER SYSTEM IS PROHIBITED. UNE SES PRIDE WRITTEN APPROVAL IS RECEIVED FROM THE CITY OF MANAURE WASTEWATER DWISION MANAGER. SEDIMENT LADEN WATER SHALL BE PRIMED THROUGH AN APPROVED SEDIMENT CONTROL BMP PRIOR TO DISPOSAL INTO THE WASTEWATER SYSTEM.
- SAWCUTTING SLURRY AND DEBRIS SHALL BE VACUUMED AND REMOVED FROM ALL IMPERVIOUS SURFACES. VACUUMED SAWCUTTING SLURRY SHALL BE PROFELY DISPOSED OF AND NOT DISCHARGED INTO THE STORM SYSTEM.
- WATER TIGHT TRUCKS SHALL BE USED TO TRANSPORT SATURATED SOILS FROM THE CONSTRUCTION SITE.
- TEMPORARY STABILIZATION AND COVERING OF SOIL STOCKPILE
   SHALL OCCUP AT THE END OF EACH WORK DAY
- ALL TOXIC OR HAZARDOUS MATERIALS SHALL BE PROPERLY STORED, APPLIED, AND DISPOSED.
- AN AREA SHALL BE DESIGNATED FOR WASHING OUT CONCRETE
  TRUCKS SUCH THAT RUNOFF FROM WASHING ACTIVITIES ARE
  CONTAINED AND DO NOT LEAVE THE SITE OR ENTER THE STORM
  SYSTEM.
- 12. SWEEPINGS FROM EXPOSED AGGREGATE CONCRETE SHALL NOT BE WASHED TO THE STREET OR STORM SYSTEM. SWEEPINGS SHALL BE COLLECTED AND PROPERLY DISPOSED OF IN THE TRASH.
- PAVING IN WET WEATHER WHEN PAVING CHEMICALS CAN RUNOFF INTO THE STORM SYSTEM IS PROHIBITED.
- 14. TRACKING OF DRT AND DEBRIS ONTO IMPERVIOUS SURFACES, SUCH AS STREETS AND PARKING LOTS, IS PROHIBITED. IMPERVIOUS SURFACES SHALL BE KEPT FREE OF DIRT AND DEBRIS AT ALL TIMES IF IT CAN BE SPREAD BY TRAFFIC OR CAN ENTER THE STORM SYSTEM.
- GRAVEL OR DIRT CURB RAMPS ARE PROHIBITED. ONLY WOOD STEP STYLE CURB RAMPS ARE ALLOWED.
- UPON COMPLETION OF SITE RESTORATION AND APPROVAL FROM THE CITY OF MILWAUKIE ENGINEERING DIRECTOR, ALL TEMPORARY EROSION CONTROL MEASURES MAY BE REMOVED.
- DRAINAGE FROM SPRINGS OR GROUNDWATER MUST BE ADDRESSED DURING CONSTRUCTION BY THE CONTRACTOR. DISCHARGE FROM GROUNDWATER ENCOUNTERED ON THE SITE MUST BE CLEAN OF SEDMENT OR POLLUTANTS.
- AREAS SUBJECT TO WIND EROSION SHALL USE APPROPRIATE DUST CONTROL MEASURES INCLUDING THE APPLICATION OF A FINE SPRAY OF WATER PLASTIC SHEETING, STRAW MULCH, OR OTHER APPROVED MEASURES.
- DATES OF IMPLEMENTATION OF WET WEATHER MEASURES ARE OCTOBER 1ST TO APRIL 30TH.
- MATERIALS SHALL NOT BE STOCKPILED ON PUBLIC STREETS OR IN THE RIGHT OF WAY FOR LONGER THAN IMMEDIATE USE.











Project: Scott Park, Balfour Park, & Bowman Brae Park

Submittal: Design Development Sheet Title - Scott Park: EROSION CONTROL PLAN

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 Checked By:
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 Approved:
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C3.01 Sheet No. 07 of 52

SITE MATERIALS KEY NOTES DETAIL /SHEET(S) SPEC SECTION ITEM 1.0 PAVEMENTS, CURBS 1.1 PERMEABLE CONCRETE PAVING 1.2 RUBBER TILE PLAY SURFACING 1.3 CONCRETE CURB 8/L28.01 2.0 JOINTING, STRIPING 2.1 DOWELED EXPANSION JOINT 2/L28.01 2.2 CONTRACTION JOINT 2/L28.01 2.3 DUMMY JOINT 2/L28.01 WALLS

3.1 CONCRETE RETAINING WALL 9/L28.01

4.0 FENCES

4.1 SPLIT RAIL FENCE

4.2 CHAIN LINK FENCE 4.3 GATE

5.0 SITE LIGHTING

5.1 EXISTING LAMP

6.0 MISCELLANEOUS SITE FEATURES

6.1 PICNIC TABLE 3/L28.02 6.2 6' BENCH 1/L28.02 6.3 BICYCLE RACK 2/L28.02 6.4 BOULDER 6.5 RELOCATED PLAQUE

6.6 INTERPRETIVE SIGN & POST

6.7 DRINKING FOUNTAIN 6.8 PLAY STRUCTURE

4/L28.02

SITE MATERIALS GENERAL NOTES

THE WINT LEVIALS OF SUPERFACT WOLLS.

REFER TO SHEET 14.00 FOR SITE MATERIALS NOTES AND LEGEND.

GENERAL MATERIALS NOTES APPLY TO ALL SITE MATERIALS DRAWINGS.

NUMBERS IN HEXAGONS REFER TO SITE MATERIALS PLAN REFERENCE

NOTES AS SHOWN ON THE PLANS.







Project: Scott Park, Balfour Park, & Bowman Brae Park

Submitted: Design Development Shares Statement Shares Statement Shares Tritle — Scott Park : Materials Notes

Drawn By:	GM/YC
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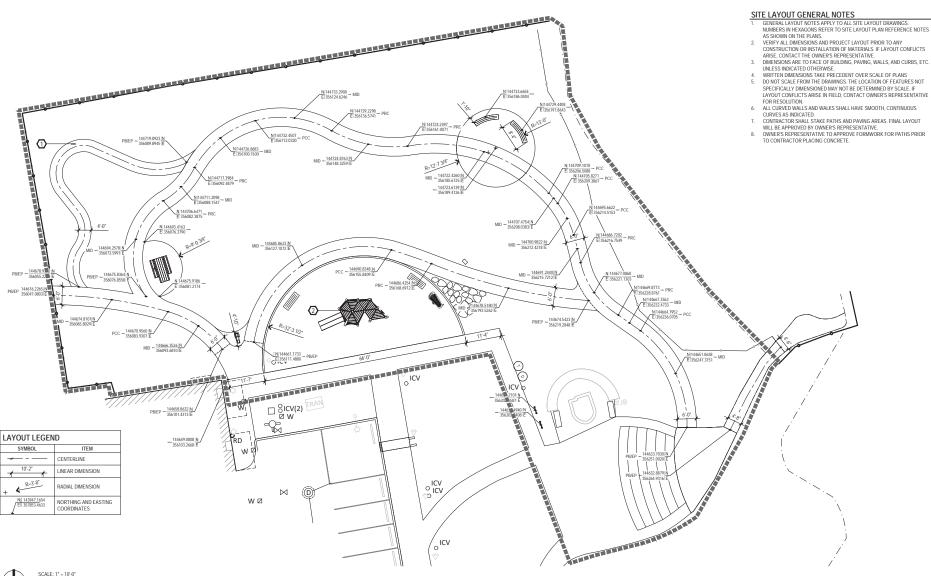


CITY OF MILWAUKIE

Project: Scott Park, Balfour Park, & Bowman Brae Park

Submittal: Design Development Sheet Title - Scott Park: Materials Plan

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	BJ/GM
Checked By:	DJ/GIVI





MULCH PATH TO BE STAKED IN THE FIELD UNDER LA SUPERVISIO PLAY STRUCTURE FINAL DESIGN AND LAYOUT T.B.D.

GENERAL LAYOUT NOTES APPLY TO ALL SITE LAYOUT DRAWINGS.
NUMBERS IN HEXAGONS REFER TO SITE LAYOUT PLAN REFERENCE NOTES

- WITH THE DIMENSIONS THAN PROCEDED TO VER SEALE OF FEATURES NOT DO NOT SCALE FROM THE DRAWINGS. THE LOCATION OF FEATURES NOT SPECIFICALLY DIMENSIONED MAY NOT BE DETERMINED BY SCALE. IF LAYOUT CONFLICTS ARISE IN FIELD, CONTACT OWNER'S REPRESENTATIVE



CITY OF MILWAUKIE

Project: Scott Park, Balfour Park, & Bowman Brae Park

Submittal: Design Development
Sheet Title - Scott Park:
Layout Plan

late:	04/11/2023
tevisions:	

Drawn By:	GM/YC
Checked By:	BJ/GM
Job No.	210234.1
Approved:	GW

L5.01 Sheet No. 10 of 52

#### GRADING GENERAL NOTES

GENERAL GRADING NOTES APPLY TO ALL SITE GRADING DRAWINGS.
NUMBERS IN HEXAGONS REFER TO SITE GRADING PLAN REFERENCE NOTES
AS SHOWN ON THE PLANS.




CITY OF MILWAUKIE

Project: Scott Park, Balfour Park, & Bowman Brae Park

Submittal: Design Development Sheet Title – Scott Park: Grading Plan

Drawn By:	GM/YC
Checked By:	BJ/GM
Job No.	210234.1
Approved:	GW

L6.01 Sheet No. 11 of 52

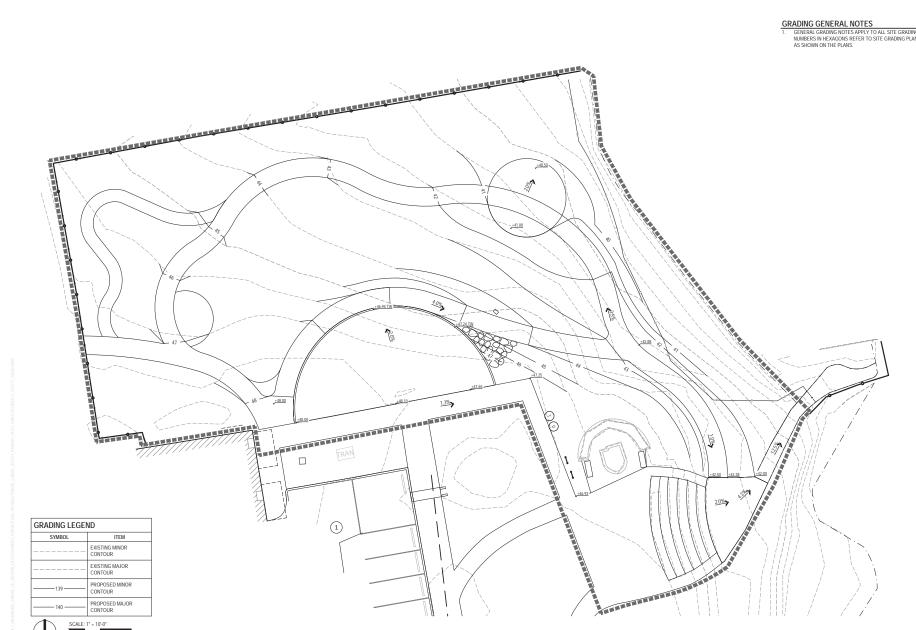

NORTH

#### IRRIGATION SCHEDULE

 SYMBOL
 DESCRIPTION
 OTY
 PRECIP
 PSI
 GPM

 LAWN ROTATOR
 3,326 S.F.
 0.45 inh
 40
 16

 SYMBOL
 MANUFACTURE RMODEL/DESCRIPTION
 7,364 S.F.
 0.45 inh
 40
 34

SYMBOL MANUFACTURER/MODEL/DESCRIPTION
RAIN BIRD PEB 1"

1", 1-1/2", 2" PLASTIC INDUSTRIAL VALVES. LOW FLOW OPERATING CAPABILITY, GLOBE CONFIGURATION.

POINT OF CONNECTION 1 1/2"

EXISTING IRRIGATION POINT OF CONNECTION -REFURBISH EXISTING BACKFLOW PREVENTOR AND

REFURBISH EXISTING BACKFLOW PREVENTOR AND ISOLATION VALVES IRRIGATION LATERAL LINE: PVC CLASS 200 SDR 21 3/4"

IRRIGATION LATERAL LINE: PVC CLASS 200 SDR 21 1"

RRIGATION MAINLINE: PVC SCHEDULE 40

CONTROL VALVE TARGET

•

XX



#### IRRIGATION GENERAL NOTES

- REFER TO SHEETS L7.01 FOR IRRIGATION PLANS AND SHEET L8.01 FOR PLANTING PLAN
- REFER TO SHEETS L29.01, L29.02, L29.03 FOR IRRIGATION DETAILS.
- B. GENERAL IRRIGATION NOTES APPLY TO ALL IRRIGATION DRAWINGS.
  NUMBERS IN HEXAGONS ( ) REFER TO IRRIGATION PLAN KEY NOTES
  AS SHOWN ON THE PLANS.
- 4. THE CONTRACTOR SHALL INSPECT THE SITE PRIOR TO CONSTRUCTION AND VERRY THE EXTENT OF THE WORK REQUIRED. COMMANCEMENT OF CONSTRUCTION BY THE CONTRACTOR DESIGNATES ACCEPTANCE OF THE SITE COMMINIONS APPRAEAT AT OUTSET. THE CONTRACTOR SITE OF THE SITE COMMINIONS PROPAGE AT OUTSET. THE CONTRACTOR SITE OF THE CONTRACTOR OF THE CONTRACTOR
- 5. CONTRACTOR SHALL VERIFY LOCATE AND PROTECT ALL EXISTING UTILITIES STRUCTURES, AND SERVICES BEFORE COMMENCING WORK. THE LOCATION OF UTILITIES. STRUCTURES AND SERVICES SHOWN ON THESE PLANS ARE APPROXIMATE ONLY. ANY DISCREPANCIES BETWEEN THESE PLANS AND THE ACTUAL FIELD CONDITIONS SHALL BE REPORTED TO THE OWNERS REPRESENTATIVE MINEDIATELY.
- THE CONTRACTOR SHALL PROTECT ALL AREAS OF WORK DEFINED ON THE DRAWINGS AND ANY EXISTING ON-SITE VEGETATION, STRUCTURES, UTILITIES, ETC. ALL DAMAGE AS A RESULT OF WORK UNDER THIS CONTRACT SHALL BE REPAIRED AT NO COST TO THE OWNER.
- 7. THE CONTRACTOR SHALL PROTECT THE EXISTING SYSTEM AND MAINTAIN ITS PERFORMANCE AT ALL TIMES DURING THE WORK OF THIS SECTION UNLESS OTHERWISE APPROVED BY THE OWNERS REPRESENTATIVE. THE CONTRACTOR SHALL CAP ALL LINES THAT ARE CUT BY NEW CONSTRUCTION AND/OR RE-POUTE TO MAINTAIN SYSTEM PERFORMANCE. UNLESS OTHERWISE NOTED IN THE CONTRACT DOCUMENTS THE CONTRACTOR SHALL RETURN TO THE OWNER ALL SALVAGED EADS, ELECTRICAL COMPONENTS AND VALVE BOXES NOT USED IN THIS CONSTRUCTION.
- WHEN NECESSARY DURING CONSTRUCTION THE CONTRACTOR SHALL
  MAKE ARRANGEMENTS FOR IRRIGATION SHUTDEF THROUGH THE OWNER'S
  REPRESENTATIVE. THE CONTRACTOR SHALL PROVIDE COMPLETE
  TEMPORARY IRRIGATION TO ALL LANDSCAPE AREAS AFFECTED BY THE
  SHUT-OFF, DURING NORMAL WATERING SEASON.
- THE CONTRACTOR SHALL MAINTAIN, REPAIR OR REPLACE CONTROLLER WIRNING AFFECTED BY CONSTRUCTION AND INTEGRATE NEW SYSTEM REQUIREMENTS INTO THE EXISTING CONTROLLER. VERIFY WHETHER OR NOT THE EXISTING CONTROLLER WILL ACCOMMODATE THE ADDITION OF NEW INFRIGATION ZONES OR ANY OTHER NEW WATERING REQUIREMENTS.
- SYSTEM OPERATION AND DESIGN IS BASED ON XX POUNDS OF PRESSURE AND XX GALLONS PER NINUTE AT THE SHUTOFF VALVE. THE CONTRACTOR SHALL VERIFY THE DESIGN PRESSURE AND VOLUME BEFORE INSTALLATION AND NOTIFY OWNER IF THERE IS A DISCREPANCY.
- CONTRACTOR SHALL REFERENCE PLANTING PLAN(S) PRIOR TO INSTALLATION OF VALVES. LOCATE VALVES IN PLANTING BEDS WHEREVER POSSIBLE. ADJUST VALVE LOCATIONS TO ELIMINATE CONFLICT WITH PROPOSED PLANTINGS AND PLANTING PATTERNS.
- 12. VALVE LOCATIONS AND MAINLINE TRENCHES SHALL BE STAKED BY THE CONTRACTIOR AND APPROVED BY THE OWNERS REPRESENTATION FROM TO INSTALLATION OF NEW IRRICATION SYSTEM PLACE ALL VALVES IN VALVE BOXES IN A MAINER THAT FACILITIES ACCESS FOR MAINTENANCE. SIZE BOXES TO ACCOMMODATE COMPLETE VALVE ASSEMBLY.
- THE CONTRACTOR SHALL VERIFY THE DIMENSIONS AND LAYOUT OF ALL NEW PLANTING AND LAWN AREAS ON SITE BEFORE STARTING WORK AND IMMEDIATELY NOTIFY OWNER OF ANY DEVIATIONS FROM PLAN.
- 14. NEW TREE LOCATIONS SHALL BE STAKED BY THE CONTRACTOR AND APPROVED BY THE OWNERS REPRESENTATIVE PRIOR TO INSTALLATION OF NEW IRRIGATION SYSTEM.
- THE CONTRACTOR SHALL INSTALL QUICK COUPLING VALVES A MINIMUM OF 200' ALONG MAINLINE AND AS SHOWN ON PLANS AND DETAILS.
- MAIN AND LATERAL LINES MAY BE SHOWN DIAGRAMMATICALLY FOR CLARITY. MAIN AND LATERAL LINES ADVOIN IN PAYED AREAS SHALL BE PLACED IN ADJACENT PLANTING BEDS UNLESS SPECIFICALLY SHOWN AS PASSING UNDER PAYING IN SLEEPING (SEE LEGEND FOR SLEEVE SYMBOL). THE CONTRACTOR SHALL DISTANT IN HE OWNERS REPRESENTATIVE APPROVAL BEFORE MAKING CHANGES IN ROUTING OF PIPE OR LOCATION OF VALVES.
- INSTALL AND ADJUST ALL COMPONENTS OF IRRIGATION SYSTEM TO PROVIDE UNIFORM COVERAGE AND MINIMIZE OVER SPRAY ONTO WALLS AND PAVING. CONTRACTOR IS RESPONSIBLE FOR PROVIDING A COMPLETE OPERATIONAL. J WORKING IRRIGATION SYSTEM.
- INSTALL TRACING WIRE OVER ALL PIPE. ROUTE FROM POINT OF CONNECTION TO ENDS OF PIPE.
- INSTALL PE-89 COMMUNICATION WIRE IN SEPARATE TRENCH FROM ELECTRICAL WIRING TRENCHING.
- ALL SURGE PROTECTION AND WIRE SPLICES SHALL BE CONTAINED WITHIN A VALVE BOX.
- CONSULT PROJECT ARBORIST PRIOR TO PERFORMING ANY CONSTRUCTION ACTIVITIES NEAR EXISTING TREES OR WITHIN THE SPECIFIED TREE CRITICAL ROOT ZONE.
- . THE SCALE OF THE IRRIGATION DRAWINGS ARE HALF THE SCALE INDICATED ON THE PLANS WHEN THE DRAWINGS ARE SIZE 11"X17".



LANDSCAPE ARCHITECT

110 SE Main St., Suite 10 Portland, OR 9721 Ph: 503 222 561 Fax: 503 222 228





Project
Scott Park, Balfour Park,
& Bowman Brae Park
Olyz St Main Steel

Submittal: Design Development
Sheet Title - Scott Park:
Irrigation Schedule
and Notes

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Sheet No. 12 of 52



CITY OF MILWAUKIE

Project: Scott Park, Balfour Park, & Bowman Brae Park crya Manuka 1072. St. Man Steel 1072. St. Manuka 1073. St. Nat. Steel 1073. St. Nat. St. 1072.

Submittal: Design Development Sheet Title - Scott Park: Irrigation Plan

Checked By: BJ/GM Job No. 210234.1

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#### PLANT SCHEDULE



**TREES** TOTAL QTY. BOTANICAL NAME COMMON NAME SIZE & TYPE SPACING CORNUS NUTTALLII PACIFIC DOGWOOD 1.5" CAL., B&B AS SHOWN 1

SIZE & TYPE

SPACING

TOTAL QTY.

COMMON NAME BOTANICAL NAME TURF SEED MIX: PERENNIAL RYEGRASS LOUIUM PERENNE FESTUCA ARUNDINACEA FINE FESCUE POA PRATENSIS KENTUCKY BLUEGRASS

SEE MANUFACTURER SPECS FOR APPLICATION RATE

SHRUBS / GROUNDCOVERS

WOODI AND MIX: ARTEMISIA FRIGIDA FRINGED SAGEBRUSH PLUG-1" DIA., 6" HT. 18" O.C. 553 SILVER SAGEBRUSH PLUG-1" DIA., 6" HT. 18" O.C. 553 ERIGERON PULCHELLUS ROBIN'S PLANTAIN KINNIKINNICK PLUG-1" DIA., 6" HT. 24" O.C. 20% 40% 359 1277 ARCTOSTAPHYLUS UVA-URSI PLUG-1" DIA., 6" HT. 18" O.C. LOW NATIVE MIX-LUZULA SYLVATICA GREATER WOOD RUSH PLUG-1" DIA., 6" HT. 24" O.C. LIRIOPE MUSCARI SILVERY SUNPROOF PLUG-1" DIA., 6" HT. 12" O.C. 254 20% 'SILVERY SUNPROOF' LILYTURF CAREX CARYOPHYLLEA THE BEATLES PLUG-1" DIA., 6" HT. 12" O.C. 254 20% THE BEATLES' VERNAL SEDGE VERONICA AMERICANA AMERICAN SPEEDWELL PLUG-1" DIA., 6" HT.12" O.C. 381

PLANT SAME SPECIES IN GROUPS OF 3, 5, OR 7

## PLANTING REFERENCE NOTES

EXISTING PLANTING AREA TO REMAIN, PRESERVE AND PROTECT.







## PLANTING GENERAL NOTES

- PROVIDE PLANTING SOIL AND BARK MULCH TO THE COMPOSITION AND DEPTHS IN ACCORDANCE WITH THE DRAWINGS AND SPECIFICATIONS OF THE CONTRACT DOCUMENTS
- 2. INSTALL PLANTS IN ACCORDANCE WITH THE DRAWINGS AND THE SPECIFICATIONS OF THE CONTRACT DOCUMENTS.

  3. PLANT QUANTITIES ARE LISTED FOR CONVENIENCE ONLY, ALL COUNTS MUST BE VERIFIED PRIOR TO INSTALLATION. IN THE CASE OF A DISCREPANCY BE VERIFIED PRIOR TO INSTALLATION. IN THE CASE OF A DISCREPANCY
  BETWEEN THE LEGEND AND THE PLAN, PLANTS INDICATED ON THE PLAN SHALL
  SUPERCEDE QUANTITIES LISTED IN THE LEGEND.
  4. UTILITY LOCATIONS SHOWN ON PLANS MAY DIFFER FROM FIELD CONDITIONS.
- CONTRACTOR TO FIELD VERIFY ALL UTILITIES BEFORE INSTALLATION.
  CONFLICTS BETWEEN ANY EXISTING AND PROPOSED UTILITIES ARE TO BE BROUGHT TO THE ATTENTION OF THE OWNER'S REPRESENTATIVE IMMEDIATELY.


  5. PLANTS INDICATED TO BE INSTALLED IN STORMWATER FACILITIES DESIGNED
- PLANI'S NUCCATED TO BE, INSTALLED IN STORMWATER AROUT HES DESCINCE. TO BE FREQUENTLY HUNDRATE OF OWATER DEPTH AROUT HES MALLEST INSTALLED PLANT HERIOTH, SHALL BE ENTIRELY DEWATERED PRIOR TO PLANT INSTALLATION, PLANTS INSTALLED IN STORMWATER FACILITIES WITH ANTICIPATED HIGH WATER LEVELS MAY BE INSTALLED OUTSIDE THE SPECIFIED PLANT INSTALLATION WINDOW IF ADDITIONAL SUPPLEMENTAL RIRIGATION IS PROVIDED.

Project: Scott Park, Balfour Park, & Bowman Brae Park

Submittal: Design Development Sheet Title – Scott Park: Plant Schedule and Notes

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L8.00 Sheet No. 14 of 52



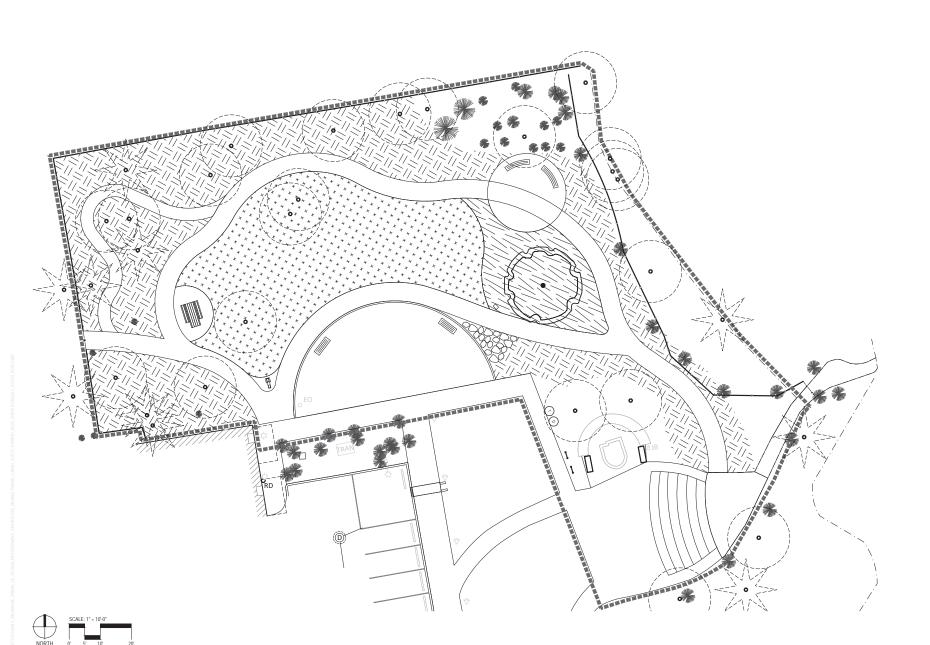

CITY OF MILWAUKIE

Project: Scott Park, Balfour Park, & Bowman Brae Park crya Manuka 1072. St. Man Steel 1072. St. Manuka 1073. St. Nat. Steel 1073. St. Nat. St. 1072.

Submittal: Design Development Sheet Title – Scott Park: Planting Plan

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 BJ/GM


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 GW

L8.01 Sheet No. 15 of 52

NOTES:
1. DIP MJ SPOOL. "L.F." DIP CONTRACTOR TO VERIFY LENGTH OF "DIP NECESSARY TO MEET WATERLINE CLEARANCE TYP.
2. CONC. ANCHOR BLOCK WI TIE BOLTS, DUCT LUGS OR STEEL PLATE AS APPROVED

TYPICAL WATERLINE UTILITY CROSSING

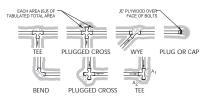


- 1. CONCRETE THRUST BLOCKING TO BE POURED AGAINST UNDISTURBED EARTH.
- 2. KEEP CONCRETE CLEAR OF JOINT AND ACCESSORIES.
- THE REQUIRED THRUST BEARING AREAS FOR SPECIAL CONNECTIONS ARE SHOWN ENCIRCLED ON THE PLAN; e.g. 15 INDICATES 15 SQUAREDET BEARING AREA REQUIRED.
- IF NOT SHOWN ON PLANS REQUIRED BEARING AREAS AT FITTING SHALL BE AS INDICATED BELOW, ADJUST IF NECESSARY, TO CONFORM TO THE TEST PRESSURE(S) AND ALLOWABLE SOIL BEARING STRESS (ES) STATED IN THE SPECIAL SPECIFICATIONS.
- BEARING AREAS AND SPECIAL BLOCKING DETAILS SHOWN ON PLANS TAKE PRECEDENCE OVER BEARING AREAS AND BLOCKING DETAILS SHOWN ON THIS STANDARD DETAIL.

#### BEARING AREA OF THRUST BLOCK IN SQUARE FOOT

			PLUGO	EE SED ON JN			
FITTING SIZE	TEE, WYE, PLUG, OR CAP	90" BEND PLUGGED CROSS	A1	A2	45" BEND	22½° BEND	11½° BEND
4	1.0	1.4	1.9	1.4	1.0		
6	2.1	3.0	4.3	3.0	1.6	1.0	
8	3.8	5.3	7.6	5.4	2.9	1.5	1.0
10	5.9	8.4	11.8	8.4	4.6	2.4	1.2


NOTE: ABOVE BEARING AREAS BASED ON TEST PRESSURE OF 150 p.s.L. AND AN ALLOWABLE SOIL BEARING STRESS OF 2000 p.s.L. TO COMPUTE BEARING AREAS FOR DIFFERENT TEST PRESSURE: AND SOIL BEARING STRESSES LIST HE FOLLOWING EQUATION BEARING AREA = (TEST PRESSURE:150)X(2000 SOIL BEARING STRESSS)X(TABLE VALUE).




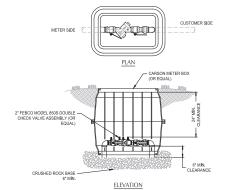

NOTE:
INSTALATION SHOWN IS ONLY A SUGGESTION. THE DISTANCE FROM BOTTOM OF DEVICE TO FINISH
GRADE, REEZE PROTECTION, AND CLEARANCE FOR TESTING 8 REPAIR ARE THE MAJOR
CONSIDERATIONS FOR INSTALLATION. PLUGS TO BE INSTALLED IN TEST COCKS OF BELLOW GROUND
INSTALLATIONS IND DISSIMILAR METALS, IF PREEZE PROTECTION IS PROVIDED, THE 24" MIN CLEARANCE
MAY BE REDUZED.



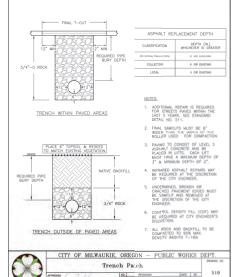

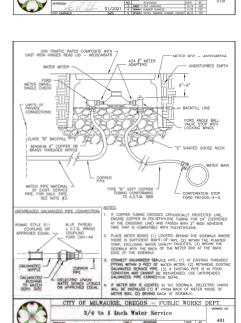









Project: Scott Park, Balfour Park, & Bowman Brae Park


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DETAILS

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C28.00 Sheet No. 46 of 52




MOTES


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1. INEFILTER PARRIC SHALL BE (38° MN, WIDTH PURCHASED IN A CONTINUOUS BOOL CUTTO TO THE
1. INEFILTER PARRIC SHALL BE (38° MN, WIDTH SHALL BE SHAL

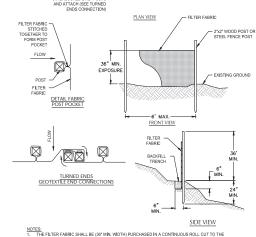- THE FILTER FABRIC FENCE SHALL BE INSTALLED TO FOLLOW THE CONTOURS WHERE FEASIBLE. THE FENCE POSTS SHALL BE SPACED A MAXIMUM OF 6-FEET APART AND DRIVEN SECURELY INTO THE GROUND A MINIMUM OF Z-HOVIES.
- THE FILTER FABRIC SHALL HAVE A MINIMUM VERTICAL BURIAL OF 6-INCHES. ALL EXCAVATED MATERIAL FROM FILTER FABRIC FENCE INSTALLATION, SHALL BE BACKFILLED AND COMPACTED, ALONG THE ENTIRE DISTURBED AREA.
- STANDARD OR HEAVY DUTY FILTER FABRIC SHALL HAVE MANUFACTURED STITCHED LOOPS FOR 2½2'
  POST INSTALLATION. STITCHED LOOPS WITH STAKES SHALL BE INSTALLED ON THE DOWN-HILL SIDE
  OF THE SLOPED AREA.
- FILTER FABRIC FENCES SHALL BE REMOVED WHEN THEY HAVE SERVED THEIR USEFUL PURPOSE, BUT NOT BEFORE THE UP-SLOPE AREA HAS BEEN PERMANENTLY PROTECTED AND STABILIZED.
- FILTER FABRIC FENCES SHALL BE INSPECTED BY CONTRACTOR IMMEDIATELY AFTER EACH RAINFALL AND AT LEAST DAILY DURING PROLONGED RAINFALL. ANY REQUIRED REPAIRS SHALL BE MADE IMMEDIATELY.



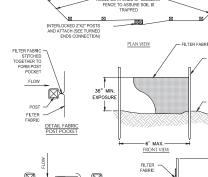

ANGLE BOTH ENDS OF SEDIMENT

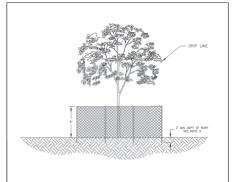

INLET SEDIMENT PROTECTION

- THEN THE THOR TO AN ORIGINAL FENONG BEING INSTALLEU UK ANTARES SOUNG REPROMINING THE COMPLETION OF CONSTRUCTION ACTIVITIES. MOVEMENT OR FEMALE IN THACE UNTIL THE COMPLETION OF CONSTRUCTION ACTIVITIES. MOVEMENT OR FENCE REQUIRES AND ACTIVITIES ACTIVITIES REPRESENTATIVE.

CITY O	OF MILWAUKI	E. OREGON - PUB	LIC WORL		
3	Tree Pro	tection Fencing			WING NO.
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Project Scott Park, Balfour Park, & Bowman Brae Park 1072 St Wanssee 1072 St Wans Steel 803 186-585


Submittal: Design Development Sheet Title: DETAILS

Drawn By: CK/RC

 Checked By:
 JZ

 Job No.
 210234.1

C28.01 Sheet No. 47 of 52

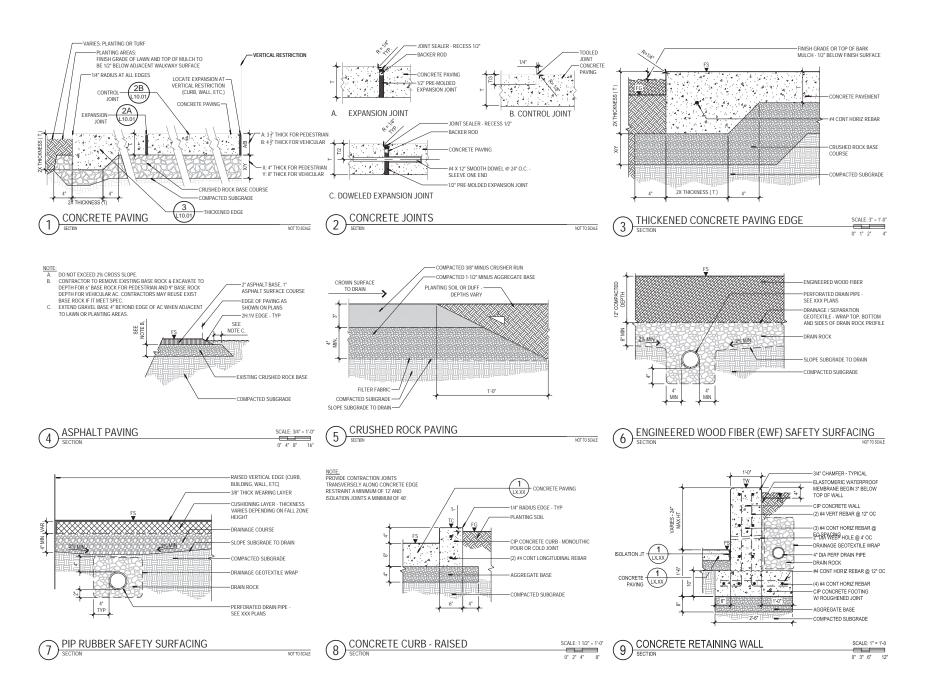

LANDSCAPE ARCHTECTU ENVRONMENTAL DES 110 SE Main S. Jusie Portlan, OR 97.





Project Scott Park, Balfour Park, & Bowman Brae Park

SITE DETAILS

© CREENWOORS, P.C.

© 2021, ALL REGISTS SECSEIVED

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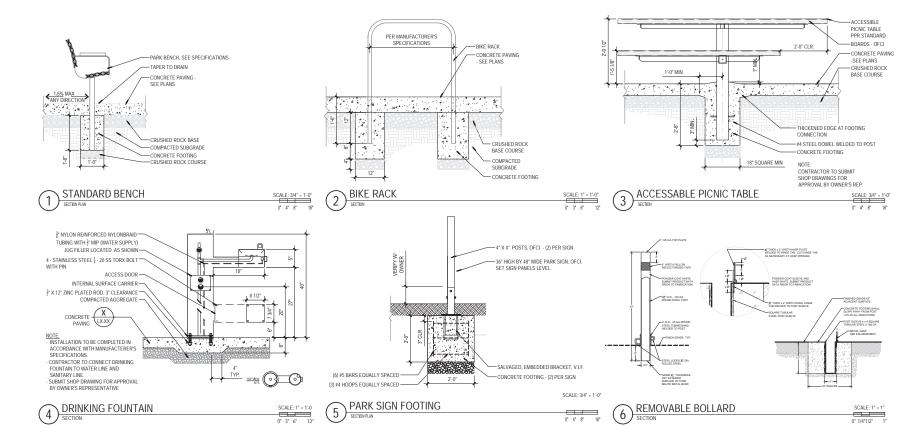
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 GM/YC

 Checked By:
 BJ/GM

 Job No.
 210234.1

L28.01

Sheet No.



0" 4" 8"





Project: Scott Park, Balfour Park, & Bowman Brae Park

Submittal: Design Development SITE DETAILS

Drawn By: GM/YC 
 Checked By:
 BJ/GM

 Job No.
 210234.1
 210234.1

Sheet No. 49 of 52

**M**ANANIVANAN



NOTE: ROTOR HEAD SHALL BE A MINIMUM OF 1" AND MAXIMUM OF 3" FROM EDGE

OF WALK, PAVING, CURB, OR EDGER.

NOT TO SCALE

TOP OF BARK MULCH TOP OF TURE / LAWN POPLIE ROTOR HEAD -PVC SCH 80 NIPPLE PVC SCH 40 STREET ELL VC SCH 80 NIPPLE - 1" X 8" MIN LATERAL LINE PVC SCH 40 STREET ELL


PVC SCH 40 ELBOW OR TEE

# ROTOR HEAD - PVC SWING JOINT ASSEMBLY

NOTES:

1. LOCATION OF QUICK COUPLER IN VALVE BOX IS SHOWN FOR LINE SIZED GATE VALVE QUICK COUPLER ASSEMBLY INSTALL PER DETAIL CLARIFICATION ONLY INSTALL VALVE BOX - RECTANGULAR OFF-SET FROM MAINLINE. EXACT FITTING REQUIREMENTS. -COILED WIRE - 30" LENGTH COMPONENT SHAPES AND SEQUENCE MAY DIFFER FROM -WATERPROOF WIRE CONNECTOR - TYP TOP OF BOX FLUSH IN LAWN AND 1/2" ABOVE BARK MULCH IN PLANTING BEDS VALVE ID TAG REMOTE CONTROL VALVE -I ATERAL LINE UNION - EACH SIDE OF VALVE -(4) 4 X 8 X 8 MASONRY BLOCK - TYP FILTER FABRIC 6" MIN DEPTH DRAINAGE BACKFILL -MAINLINE

REMOTE CONTROL VALVE ASSEMBLY

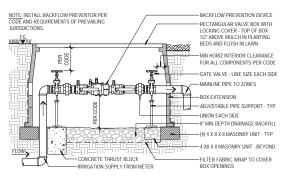

## BACKFLOW PREVENTION DEVICE ASSEMBLY

NOT TO SCALE

10" ROUND VALVE BOX

FILTER FABRIC

-MAINLINE

SCH 40 PVC STREET ELL

SCH 40 ELBOW OR TEE

SCH 40 PVC STREET ELL

WORM DRIVE HOSE CLAMPS

SCH 40 PVC T X T 90 DEG ELL

CONTROLLER - PEDESTAL MOUNT

NOT TO SCALE

STAINLESS STEEL EXTERIOR CONTROLLER

-ZINC PLATED STEEL BASE WITH STAINLESS

MANUFACTURER'S INSTRUCTIONS

MOUNTING STUDS SET IN CONCRETE BASE PER

CONCRETE BASE ON COMPACTED SUBGRADE

3" DIA SWEEP ELL PVC CONDUIT FOR COMMON

1" DIA PVC CONDUIT FOR 120 VAC ELECTRICAL

SERVICE STUB BY ELECTRICAL CONTRACTOR

0.50

AND CONTROL WIRE - 5' BEYOND EDGE OF

ACCESS DOOR

ROUND VALVE BOX

EDGE OF PLANTER BED

RECTANGULAR VALVE BOX - TYP

ENCLOSURE - PEDESTAL MOUNT WITH LOCKING

TOP OF BOX FLUSH IN LAWN / 1/2" ABOVE MULCH IN PLANTING BEDS QUICK COUPLER VALVE - MOUNT ABOVE BASE OF VALVE BOX AND ADJUST HT AS NECESSARY TO ACCEPT KEY -(4) STANDARD UNIT PAVING BLOCK -6" DEPTH DRAINAGE BACKEILL SCH 80 PVC NIPPLE - 3/4" X 8" MIN SCH 80 PVC NIPPLE - 3/4" X 8" MIN NOTES:

1. VALVE BOX LID COLOR SHALL BE PER IRRIGATION SPECIFICATIONS. #4 REBAR X 36" LONG - FASTEN WITH (2) SSTL

NOTES: 1. CONCRETE BASE SHALL

DIRECTIONS

EXTEND AS INDICATED

BEYOND CONTROLLER IN ALL

ALL WIRES SHALL BE INSTALLED PER LOCAL CODE.

FOLLOW MANUFACTURER'S

RECOMMENDATION FOR


MOUNTING INSTRUCTIONS

- VALVE BOXES TO BE INSTALLED TO ALLOW FOR ORDERLY ARRANGEMENT.
  LOCATION OF VALVE ASSEMBLIES SHALL BE STAKED FOR APPROVAL BY OWNER'S REPRESENTATIVE.
- CENTER VALVE BOXES OVER VALVE ASSEMBLIES

VALVE BOX LAYOUT

5. SET VALVE BOXES WITH TOPS AT EQUAL ELEVATIONS UNLESS STATED OTHERWISE.

QUICK COUPLER VALVE ASSEMBLY 5

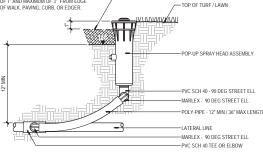

SPRAY HEAD - SWING JOINT ASSEMBLY 8

NOT TO SCALE


CITY OF MILWAUKIE


Project: Scott Park, Balfour Park, & Bowman Brae Park


IRRIGATION DETAILS

Checked By: BJ/GM 210234.1

Sheet No.

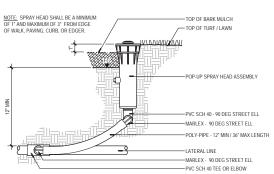

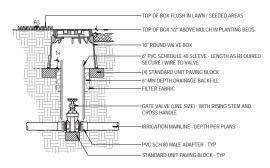

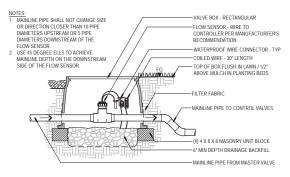

ISOLATION VALVE ASSEMBLY

FLOW SENSOR

NOT TO SCALE


CITY OF MILWAUKIE


Project: Scott Park, Balfour Park, & Bowman Brae Park

IRRIGATION DETAILS

Checked By: BJ/GM Job No. 210234.1

Sheet No. 51 of 52

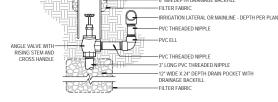


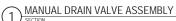

NOTES:

1. CONFIRM THE SUBGRADE IS AT THE PROPER ELEVATION PRIOR TO FINAL PLANTING SOIL INSTALLATION.

SUBGRADE TO SLOPE TO SUBSURFACE DRAINAGE LINES
AND AWAY FROM STRUCTURES IF PRESENT.

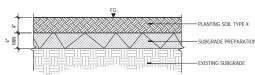

OC SPACING

TYP

PLANT SPACING DIAGRAM

NOT TO SCALE

SHRUB CONTAINER PLANTING W/ PLANTING SOIL

NOT TO SCALE

NOT TO SCALE

CITY OF MILWAUKIE

Project: Scott Park, Balfour Park, & Bowman Brae Park

PLANTING DETAILS Submittal: Design Development

Checked By: BJ/GM 210234.1

L30.01 Sheet No. 52 of 52

SUBGRADE PREPARATION

PLANTING SOIL TYPE X

GROUNDCOVER PLANTING

NOTE: PRIOR TO PLANTING, REMOVE PLANT FROM

TEASING OR SCRATCHING ROOT MASS.

CONTAINER AND LOOSEN SIDES BY LIGHTLY

NOT TO SCALE

GROUNDCOVER - TYP

-SET ROOT CROWN 1/2" ABOVE FINISH GRADE - TYP

BARK MULCH - KEEP 1" AWAY

1 LX.XX PLANTING SOIL

NOTES:

1. ROOT CROWN TO BE VISIBLE BEFORE TREE IS SET, REMOVE TOP OF ROOT BALL MEDIA TO LOCATE IF NEEDED.

2. REMOVE TWINE, METAL BASKET, AND BURLAP ENTIRELY FROM ROOT BALL AFTER TREE IS SET. BURLAP SHALL BE

CUT DOWN TO BASE OF ROOT BALL (DO NOT FOLD BURLAP).
BURLAP ON BOTTOM MAY REMAIN IF NON-SYNTHETIC. ALL
MATERIALS REMOVED FROM ROOT BALL PACKAGING SHALL BE REMOVED FROM PLANTING PIT.

FROM TRUNK REMOVE ROOT BALL PACKAGING AFTER TREE IS SET - SEE NOTE 2 BALL TO STABILIZE TREE -PLANTING SOIL

EDGE OF PLANT BED OR

ADJACENT PLANT MASSING

ON PLANTING PLAN - TYP

LINEESS INDICATED OTHERWISE

-EDGE OF PAVEMENT, CURB OR OTHER HARD SURFACE

AREA FOR PLANT SPACING ADJUSTMENT

-CONTINUOUS EQUALLY SPACED OUTER ROW AT EDGE OF PLANTING BED - FOLLOW

BEDLINE AS DELINEATED ON THE PLANTING PLAN AND LOCATE PLANTS ONE-HALF OF

ALL PLANTS SHALL BE PLANTED AT EQUAL TRIANGULAR OC SPACING AS SPECIFIED

LOCATE PLANTS ONE-HALF OF ON-CENTER

SPACING DISTANCE PLUS 6" FROM ANY CURB, SIDEWALK, OR OTHER HARD SURFACE

SET ROOT CROWN (TRUNK FLARE) 2" ABOVE FINISH GRADE - SEE NOTE 1


-RARK MILLOH - KEEP 4" MIN AWAY

ON CENTER DISTANCE FROM EDGE OF BEDLINE, OR ADJACENT PLANT MASSING, UNLESS INDICATED OTHERWISE

-LIGHTLY TAMP SOIL AROUND ROOT SCARIFY SIDES AND BOTTOM OF EXCAVATION -ROOT BALL TO REST ON STABLE EXISTING SUBGRADE OR RECOMPACTED SUBGRADE SOIL 2X ROOT BALL DIA

TREE PLANTING - B&B W/ PLANTING SOIL

NOTE: PRIOR TO PLANTING, REMOVE PLANT FROM CONTAINER AND LOOSEN SIDES BY LIGHTLY TEASING OR SCRATCHING ROOT MASS SET CROWN OF ROOT BALL 1" ABOVE FINISH GRADE BARK MULCH - KEEP 2" AWAY FROM CROWN 1) PLANTING SOIL LXXX LIGHTLY TAMP PLANTING SOIL FIRM AT BASE WHERE ROOT BALL RESTS - DO NOT COMPACT

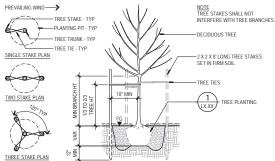

DECIDUOUS TREE - STAKING (6)

Milwaukie Parks Land Use Planning and Permitting

**Scott Park Application** 

Exhibit E – Property Deeds



#### WARRANTY DEED

KNOW ALL MEN BY THESE PRESENTS, That Rosalie Adams Denny, hereinafter called the grantor, for the consideration hereinafter stated, to grantor paid by City of Milwaukie, a municipal corporation, hereinafter called the grantee, does hereby grant, bargain, sell and convey unto the said grantee and grantee's heirs, successors and assigns, that certain real property, with the tenements, hereditaments and appurtenances thereunto belonging or appertaining, situated in the County of Clackamas and State of Oregon, described as follows, to-wit:

A part of the William Meek Donation Land Claim in Township 1 South, Range 1 East, Willamette Meridian, Clackamas County, Oregon: beginning at an iron rod in the Northern boundary of the plat of Lewelling Park recorded in Book 7, Page 14, Record of Town Plats of Clackamas County, Oregon, which point is North 80°10' East 85.04 feet distance from the Northwest corner of Lot 3, Block 3 of said Town Plat running thence North 8° 58' West 103, 32 feet to an iron rod; thence North 81°2' East 257, 55 feet to an iron pipe in the West boundary of Streib's First Addition to Milwaukie, which point is South 1°31' East 398, 45 feet distance from a basalt stone set. at the Northwest corner of said plat; thence South 1°31' East tracing the Western boundary of Streib's First Addition to Milwaukie to an iron bar at the Northwest corner of Lot 1, Thence tracing the Western boundary of said Town Plat South 9°9' East 56.5 feet to the Northeast corner of Lot 4, Block 3, Lewelling Park; thence tracing the Northern boundary of Block 3 of said Town Plat South 80\*10' West 251. 75 feet to the point of beginning, containing . 5932 acres more or less.

To Have and to Hold the same unto the said grantee and grantee's heirs, successors and assigns forever.

And said grantor hereby covenants to and with said grantee and grantee's heirs, successors and assigns, that grantor is lawfully seized in fee simple of the above granted premises, free from all encumbrances, so long as the property is used for park purposes and Grantee provides suitable recognition that the park is dedicated to the memory of Richard Scott; when the property is no longer used for park purposes or Grantee fails to provide such suitable recognition, the interest of Grantee, its successors or assigns shall automatically terminate and the property shall revert to Grantor, her heirs or assigns; and that grantor will warrant and forever defend the said premises and every part and parcel thereof against the lawful claims and demands of all persons whomsoever, except those claiming under the above described encumbrances.

The true and actual consideration paid for this transfer, stated in terms of dollars, is none.

In construing this deed and where the context so requires, the singular includes the plural and all grammatical changes shall be implied to make the provisions hereof apply equally to corporations and to individuals.

In Witness Whereof, the grantor has executed this instrument this instrument this , 1975.

STATE OF OREGON,

County of Clackamas, )

1975

Personally appeared the above named Rosalie Adams Denny and acknowledged the foregoing instrument to be her voluntary act and deed.

Before me:

Notary Public for Oregon

My commission expires: 4-9 75

After recording return to:

City of milwaukie 926 Main Milwaukie OR 97222 STATE OF OREGON

i, George D. Poppen, County Clerk, Ex-Officio Recorder of Conveyances and Ex-Officio Clerk of the Circuit Court of the State of Gregon, for the County of Cleckemes, do hereby certify that the within instrument of writing was received for and recorded in the records of said county at

1975 APR 11 PM 2 18

8864

KNOW ALL MEN BY THESE PRESENTS, That Rosalie Adams Denny

hereinafter called the grantor, for the consideration hereinafter stated, to grantor paid by City of Milwaukie, a municipal corporation

. hereinafter called the grantee,

does hereby grant, bargain, sell and convey unto the said grantee and grantee's heirs, successors and assigns, that certain real property, with the tenements, hereditaments and appurtenances thereunto belonging or appertaining, situated in the County of Clackamas. and State of Oregon, described as follows, to-wit: A part of the William Meek Donation Land Claim in Sections 35 and 36 in Township 1 South, Range 1 East, Willamette Meridian, Clackamas County, Oregon: Beginning at an iron rod in

the Northern boundary of the plat of Lewelling Park recorded in Book 7, Page 14, Record of Town Plats of Clackamas County, Oregon, which point is North 80°10' East 85.04 feet distance from the Northwest corner of Lot 3, Block 3 of said Lewelling Park running North 8°58' West 10 feet to the TRUE POINT OF BEGINNING; Thence continuing North 8°58' West 93.32 feet to an iron rod; Thence North 81°02' East 257.55 feet to an iron pipe in the West boundary of Streib's First Addition to Milwaukie, which point is South 1°31' East 398.45 feet distance from a basalt stone set at the Northwest corner of said plat; Thence South 1°31' East tracing the Western boundary of Streib's First Addition to Milweukie to an iron bar at the Northwest corner of Block 1; Thence tracing the Western boundary of said Streib's First Addition South 9°09' East 56.5 feet to the Northeast corner of Lot 4, Block 3, Lewelling Park; Thence tracing the Northern boundary of Block 3 of said Town Plat South 80°10' West 195.04 feet to a point; Thence North 8°58' West 10 feet to a point; Thence South 80°10' West 56.71 feet to the TRUE POINT OF BEGINNING, Containing 0.58 acres more or less.

To Have and to Hold the same unto the said grantee and grantee's heirs, successors and assigns forever. And said grantor hereby covenants to and with said grantee and grantee's heirs, successors and assigns, that grantor is lawfully seized in fee simple of the above granted premises, free from all encumbrances

And said grantor hereby covenants to and with said grantee and grantee's heirs, successors And said granter hereby covenants to and with said grantee and grantee's heirs, successor, and assigns, that granter is lawfully seized in fee simple of the above granted premises, free from all encumbrances, so long as the property is used for park purposes and grantee provides suitable recognition that the park is dedicated to the memory of Richard Scott; when the property is no longer used for park purposes or grantee fails to provide such suitable recognition, the interest of grantee, its successors or assigns shall automatically terminate and the property shall revert to grantor, her heirs or assigns;

grantor will warrant and lorever delend the above granted premises and every part and parcel thereof against the lawful claims and demands of all persons whomsoever, except those claiming under the above described encumbrances.

The true and actual consideration paid for this transfer, stated in terms of dollars, is \$ none consideration (indicate which).

In construing this deed and where the context so requires, the singular includes the plural.

WITNESS grantor's hand this Page day of Explement 1976

Rosalio adams.

Rosalie Adams Denny

STATE OF OREGON, County of Clackamas

Personally appeared the above named ... Rusalie Adams Denny

, 1976 September 20

3/19/80

and acknowledged the foregoing instrument to be

voluntary act and deed.

(OFFICIAL SEAL)

Notary Public for Oregon My commission expires .

NOTS-The senionus between the symbols (). If not applicable, should be delated, See Chapter 442, Oregon Laws 1947, as amended by the 1947 Special Session

WARRANTY DEED Rosalie Adams Denny P12: TO City of Milwaukie a municipal corporation -75007 AFTER RECORDING RETURN TO STATE OF 97222

633

33

No.



#### COUNTY CLERK OF CLACKAMAS COUNTY

ROBERT SCHUMACHER, COUNTY CLERK

EX-OFFICIO CLERK OF CIRCUIT AND DISTRICT COURTS RECORDER OF CONVEYANCES

OREGON CITY, OREGON

Aug 28, 1961

Mr R. E. Osborne, City of Milwaukie, City Hall Milwaukie, Oregon

Dear Mr Osborne:

I am returning to you the receipt in the Florence Olson Ledding estate, sent to us for recording. Since the estate is a Clackemas county probated estate and the original of this receipt will necessarily become a matter of record in the estate proceedings, an independent recording of your copy of the receipt is unnecessary. This copy, I should presume, would properly be filed in your city records.

Very truly yours,

Robert Schumscher, County Clerk

encl. receipt ck #6287



### IN THE CIRCUIT COURT OF THE STATE OF OREGON

FOR CLACKAMAS COUNTY

## Probate Department

Received of THE FIRST NATIONAL BANK OF OREGON, PORTLAND and ELAM AMSTUTZ, Co-Executors under the Will of Florence Olson Ledding, Deceased, pursuant to Paragraphs Twelfth and Fourteenth of the Will of said decedent, the following property:

Right to possession of a tract in the Lot Whitcomb D.L.C. in T. 1 S. R. 1 E. of the W.M., County of Clackamas, State of Oregon, described as follows:

Beginning at a point in Section 36, said township and range, which is 113.94 feet South and 5.06 feet East of the corner of Sections 25, 26, 35 and 36, said township and range, at which point is set an iron window weight 13 inches long, 1-1/4 inches in diameter, driven 12 inches in the ground, from which a prune tree, 10 inches in diameter bears North 57° 6' West 7.55 feet distant and a prune tree eight inches in diameter bears South 52° 40' West 23.95 feet distant; thence North 80° 28' East 195.1 feet to an iron gas pipe 1½ inches in diameter, 5½ inches long, driven 2½ inches ip the ground, in Richard Scott's mill-pond; thence South 80° 15 the ground; in Richard Scott's mill-pond; thence South 80° 15 the ground; thence South 80° 15 the ground; thence South 80° 15 feet, more or less, to a point which is South 80° 58' East 377.36 feet from the point of beginning; thence North 8° 58' West 377.36 feet

A tract in the Lot Whitcomb D.L.C. in T. 1 S.R. 1 S. of the W.M., County of Clackamas, State of Oregon, described as follows:

Beginning on the Northerly boundary of Lot 3, Block 3, LEWELLING PARK, South 113.94 feet and East 5.06 feet from the corner common to Sections 25, 26, 35 and 36, said township and range; thence South 8° 58' East 377.36 feet along the Easterly line of tract described in deed recorded January 26, 1907, in Deed Book 98, Page 81, to a point in the Southerly boundary of said Lot 3, which is the true point of beginning; thence South 81° 02' West along the Southerly line of Lot 3, a distance of 5 feet; thence North 8° 58' West parallel with the Easterly line of said tract in Deed Book 98, Page 81, a distance of 180 feet; thence North 81° 02' East 5 feet to the Easterly line of said tract in Deed Book 98, Page 81; thence South 8° 58' East along said Easterly tract line 180 feet to the point of beginning; all of said property commonly known as 2105 Harrison Street, Milwaukie, Oregon.

All books remaining in the residence on the above described premises, also a globe and planetarium.

Dated this / day of May , 1961.

CITY OF MILWAUKIE

By Chan Mayor

Ву \_\_\_\_\_

rebray brounts

## FOURTEENTH

I give, devise and bequeath unto the City of Milwaukie, Clackamas County, Oregon, a municipal corporation, in perpetuity, my home, which is commonly known and described as 2105 Harrison Street, City of Milwaukie, Clackamas County, Oregon, and which property is more specifically described in that certain deed from Richard Scott and Hannah Scott to Herman F. Loeding, dated August 18, 1906, and recorded in Book No. 95, page 403 of the Deed Records of Clackemas County, Oregon, and which description is, by reference thereto, expressly made a part hereof. That my said home property is hereby given, devised and bequeathed unto said City of Milwaukie on condition and for the use, intention, object and purpose of establishing, keeping up, improving and maintaining thereon, in perpetuity, a free, public library for the uses, objects and purposes of the furtherance and advancement of education. learning, literature and science. Said library shall be open to the public, and for the use and benefit of all people, regardless of race, age, station in life, color, sex or religious faith. Said library to be so maintained in perpetuity shall be named "THE LEDDING LIBRARY" in memory of my late husband, Herman Frank Ledding, and myself. The property herein given, devised and bequeathed shall be held by the City of Milwaukie in perpetuity, shall be inalienable and shall be used for library purposes only and shall never be used in whole or in part for any other purposes.

6 - Last Will and Testament of Theue Don helling
BOOK 81 PAGE 993

I give, devise and bequeath unto Vern Wirtz such books from my library as he may select and advise my Executors, in writing, within thirty (30) days following my death.

#### TWELFTH

Following the gift, devise and bequest contained in Paragraph ELEVENTH, thereupon I give, devise and bequeath unto the City of Milwaukie, Clackamas County, Oregon, a municipal corporation, all the books remaining in my

4 - Last Will and Testament of House Olom Ledding

BOOK 81 PAGE 991

library to be used by it in its public Library, and for library purposes. This gift, devise and bequest is to include my globe and planetarium.

#### THIRTEENTH

I give, devise and bequeath unto Vern Wirtz my heirlooms, household furnishings, furniture, keepsakes and family records and documents, jewelry, books, and ornaments of the person, excepting therefrom such things as Vern Wirtz, in his sole judgment and discretion, deems might be of historical value only, and of benefit to the public, which articles shall be given by him to the Oregon Historical Society as its property. In the event Vern Wirtz predecease me, the Oregon Historical Society may select such items as it deems of purely historical value and as it shall advise my Executors, in writing, within sixty (60) days following my death, and the Oregon Historical Society shall upon such selection become the sole and exclusive owner of the items selected, and they are hereby given, devised and bequeathed to said Oregon Historical Society, and all remaining items shall revert to and shall constitute and be a part of the rest, residue

I hereby further give, devise and bequeath unto the City of Milwaukie, Clackamas County, Oregon, a municipal corporation, the sum of Five Thousand Dollars (\$5,000.00) in cash. This gift, devise and bequest of Five Thousand Dollars (\$5,000.00) in cash is given for the sole and exclusive purpose of buying books for said library, and further, on condition that at least five per cent (5%) of said Five Thousand Dollars (\$5,000.00) be used to purchase and acquire books of a liberal political and ecconomic nature. I make this condition, because it is my opinion that the new problems of the future will require new thought.

I know that the City of Milwaukie will appreciate my provision for the library and that they might establish a plaque in the entrance hall honoring my deceased husband, Herman Frank Ledding, and myself. .

### FIFTEENTH

All the rest, residue and remainder of my estate. whether real, personal or mixed property, and of whatever kind and nature, and wherever situate of which I may die, seized and possessed, and to which I may be entitled at the time of my death, I give, devise and bequeath in the following manner:

7 - Last Will and Testament of

81 PAGE 994

Milwaukie Parks Land Use Planning and Permitting

**Scott Park Application** 

Exhibit J – Amenity Image Examples





Milwaukie Parks Land Use Planning and Permitting

**Scott Park Application** 

Exhibit M – Tree Inventory



Tree No.	Common Name	Scientific Name	DBH <sup>1</sup>	Single DBH <sup>2</sup>	C-Rad <sup>3</sup>	Condition <sup>4</sup>	Structure	Comments	Treatment
100	Oregon myrtle	Umbellularia californica	10,9	13	25	good	fair	codominant at ground level and 2', overtopped by adjacent trees, bark damage at lower trunk	tbd
101	saucer magnolia	Magnolia × soulangeana	11,8	13	23	good	fair	codominant at 6" and 3'	tbd
102	saucer magnolia	Magnolia × soulangeana	9	9	3	good	fair	codominant at 1'	tbd
103	bigleaf maple	Acer macrophyllum	15	15	20	good	fair	one sided, codominant at 15'	tbd
104	western redcedar	Thuja plicata	45	45	18	good	good	at pond edge	tbd
105	red alder	Alnus rubra	6	6	9	fair	good	branch dieback	tbd
106	scoulers willow	Salix scouleriana	8	8	12	fair	poor	fallen over in pond	tbd
107	red alder	Alnus rubra	11	11	0	very poor	very poor	dead, leans over pond	tbd
108	red alder	Alnus rubra	12	12	10	poor	poor	leans over pond with some branches over path	tbd
109	willow	Salix sp.	56	56	24	poor	poor	significant dieback and heartrot in lower trunk, branching over pond and path	tbd
110	cascara	Rhamnus purshiana	1	1	2	good	good		tbd
111	red alder	Alnus rubra	23	23	13	very poor	very poor	extensive dieback, leans over path; to be removed by COM prior to start of project - 7/21/23 GW	tbd
112	black walnut	Juglans nigra	21	21	38	poor	poor	large wound with decay at root crown, epicormic growth at lower trunk, upper branch dieback; removed by NCRPD - 7/21/23 GW	tbd
113	Japanese maple	Acer palmatum	11	11	15	good	fair	multiple leaders near ground level with included bark, one sided	tbd
114	Japanese maple	Acer palmatum	7	7	17	good	fair	one sided, codominant at 3'	tbd
115	tulip poplar	Liriodendron tulipifera	37	37	36	good	fair	moderately one sided, multiple leaders at 60'	tbd
116	black walnut	Juglans nigra	26	26	33	fair	fair	one sided, upper branch dieback	tbd
117	black walnut	Juglans nigra	14	14	28	fair	fair	one sided, overtopped by adjacent trees, upper branch failures	tbd
118	sweet cherry	Prunus avium	17	17	19	good	fair	overtopped by adjacent trees, codominant at 15'	tbd
119	camellia	Camellia japonica	11	11	13	good	good	shrub, measured at ground level	tbd
120	western redcedar	Thuja plicata	39,18	42	25	good	fair	moderately one sided, codominant at ground level, multiple leaders at 50'	tbd
121	saucer magnolia	Magnolia × soulangeana	4	4	8	poor	poor	suppressed, overtopped by adjacent trees	tbd
122	camellia	Camellia japonica	2	2	4	fair	fair	shrub, suppressed, overtopped by adjacent trees	tbd
123	western redcedar	Thuja plicata	33	33	29	good	fair	upright competing leaders at 40'	tbd
124	grand fir	Abies grandis	1	1	2	good	good		tbd
125	photinia	Photinia x fraseri	5	5	10	good	fair	shrub, one sided	tbd
126	black walnut	Juglans nigra	27	27	31	good	fair	past branch failures	tbd
127	Crimson King maple	Acer platanoides 'Crimson King'	19	19	27	good	fair	one sided, ivy growth up trunk	tbd
128	black walnut	Juglans nigra	29	29	18	fair	fair	one sided, crown over parking lot, Ganoderma conk at 4' from base of trunk behind lean	tbd
129	western redcedar	Thuja plicata	1	1	2	good	good		tbd



	Tree No.	Common Name	Scientific Name	DBH <sup>1</sup>	Single DBH <sup>2</sup>	C-Rad <sup>3</sup>	Condition <sup>4</sup>	Structure	Comments	Treatment
ſ	130	western redcedar	Thuja plicata	1	1	2	good	good		tbd
	131	black walnut	Juglans nigra	27	27	32	fair	tair	one sided, hangs over townhomes, multiple upright leaders in crown	tbd

<sup>&</sup>lt;sup>1</sup>DBH is the trunk diameter in inches measured per International Society of Arboriculture (ISA) standards.

<sup>&</sup>lt;sup>2</sup>Single DBH is the trunk diameter of a multi-stem tree converted to a single number according to the following formula: square root of the sum of the squared diameter of each trunk at 4½ feet above mean ground level.

<sup>&</sup>lt;sup>3</sup>C-Rad is the approximate crown radius in feet.

<sup>&</sup>lt;sup>4</sup>Condition and Structure ratings range from very poor, poor, fair, to good.